



**SOUTH CAROLINA
ENVIRONMENTAL
LAW PROJECT**

Lawyers for the Wild Side

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June 23, 2021

VIA EMAIL AND U.S. MAIL

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Re: River Neck to Kingsburg 16-inch Gas Main | P/N: SAC 2019-01427

Dear Corps and DHEC Staff,

Thank you for the opportunity to comment on the June 8, 2021 public notice for water quality certification application submitted by the Dominion Energy (“Dominion”) for the River Neck to Kingsburg 16-inch Gas Main Project (“Project”). This letter is intended to pertain to all forthcoming permitting processes for the project that are relevant to the subjects this letter addresses. These comments are submitted on behalf of the Blue Ridge Environmental Defense League (“BREDL”), a regional, non-profit, community-based organization founded on earth stewardship, environmental democracy, social justice, and community empowerment. In brief, BREDL writes to urge the South Carolina Department of Health and Environmental Control (“DHEC,” or the “Department”) to deny water quality certification to the pipeline, as the pipeline has failed to demonstrate that it will satisfy South Carolina state water quality standards as set forth in Regulation 61-101.

As you are aware, on June 22, 2020, the Corps submitted the Joint Public Notice for the pipeline. BREDL submitted comments to both the Corps and DHEC before the public notice closed on July 6, 2020. On July 27th, 2020, we received a letter from the Corps stating that any comments received during the public notice period for SAC 2019-01427 would be considered as part of the Charleston District's decision on whether the proposed project complies with the terms and conditions of NWP 12. BREDL now submits comments on the individual State Water Quality Certification (WQC) for the Corps’ Nationwide Permit 12 (NWP 12). BREDL’s previous comments to the Corps and DHEC remain pertinent to DHEC’s evaluation of the application, and are therefore incorporated and attached to this letter as **Exhibit A**.

The Project seems to have been rushed through the approval process to meet a construction timeline laid out by the applicant, depriving the public of adequate records and time to review and comment. Due to the known - and unknown - implications of this project, we are requesting that

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your departments extend the comment period, schedule a hearing for public comment on the above-referenced permit when the public can attend in person and ultimately deny the above-referenced application. Our first and overarching objection is that the public has not been provided sufficient information to allow full, meaningful comment. The information provided is scant and the comment period is inadequate; There is no information on the water quality or cumulative impacts of this proposal, nor is any information available on the discharges associated with this project. Moreover, as outlined below, the applicant has not met its burden on demonstrating why this proposal meets both the Corps' and DHEC's guidelines to warrant approval. Because the application is incomplete and does not merit approval, we ask that the comment period be extended, request a public hearing, and request DHEC and the Corps ultimately deny the above-referenced application.

A. BACKGROUND

Dominion Energy is proposing to construct approximately 76,218 LF of new 16-inch diameter steel natural gas main that runs from River Neck Road to the Kingsburg Valve Station in Florence County, South Carolina. The project consists of the installation of a 16-inch gas main within an approximately 40-foot-wide existing easement and a 10-foot-wide expansion of the easement to the west. The proposed project will result in temporary clearing impacts to 6.326 acres of wetlands and 53 linear feet of stream, temporary excavation impacts to 8.35 acres of wetlands and 119 linear feet of stream, permanent fill impacts to 0.0041 acres of wetlands and 22 linear feet (0.0045 acre) of stream, and permanent clearing impacts to 2.986 acres of wetlands and 21 linear feet of stream. The upper portion of the project site is located within Watershed 03040201-09. Jeffries Creek, Pye Branch, and Middle Swamp are classified as FW (dissolved oxygen not less than 4 mg/l and pH between 5.0 and 8.5) and the remaining streams in the watershed are classified as FW (Freshwater). The gas main will be installed through a combination of horizontal directional drilling (HDD) and open trench excavations. The crossing under Jeffries Creek will be installed by HDD. Jeffries Creek accepts drainage from Beaverdam Creek, Gully Branch, Pye Branch, Middle Swamp, Eastman Branch, and Cane Branch. Next Polk Swamp enters the system, followed by Middle Branch, Long Branch, Boggy Branch, More Branch, and Willow Creek. The Jeffries Creek Watershed then drains into the Great Pee Dee River.

Following the initial clearing and placement of the gas main, native material will be placed to match preexisting grade and allowed to revegetate naturally. A smaller portion of the cleared areas within the ROW will be maintained as cleared land for future maintenance. The applicant is not proposing mitigation because the project will result in less than 0.01 acre of permanent fill impact in wetlands and less than 0.005 acre of permanent fill impact in streams. Dominion Energy stated the basic purpose of the proposed project is to install a gas main to support the growth in the area by providing the additional capacity and flexibility to meet the current and anticipated customer demands for natural gas. They stated that the overall purpose is to provide natural gas utilities in Florence County, South Carolina for developments requiring natural gas as an energy supply. The U.S. Army Corps of Engineers is processing the application for authorization under Nationwide Permit 12, Utility Line Activities (SAC 2019-01427).

B. ENVIRONMENTAL JUSTICE

The EPA has said “Environmental justice is the fair treatment and meaningful involvement of all people regardless of race, color, national origin, or income, with respect to the development, implementation, and enforcement of environmental laws, regulations, and policies.”¹ The EPA further states that environmental justice will be achieved when everyone enjoys the same degree of protection from environmental and health hazards, and equal access to the decision-making process, to have a healthy environment in which to live, learn, and work. *Id.* The signing of Executive Order 12,898, FEDERAL ACTIONS TO ADDRESS ENVIRONMENTAL JUSTICE IN MINORITY POPULATIONS AND LOW-INCOME POPULATIONS, in 1994 by President Clinton, incorporating environmental justice principles into the work of all federal agencies, was generally viewed as a positive step toward involving communities in environmental decision-making and protecting the health of minority and low-income communities. The order specifically requires that federal agencies make achieving environmental justice part of their missions by evaluating the effects of their programs, policies, and activities on minority and low-income populations. As the state’s environmental regulator and a recipient of federal funding, DHEC was also required to ensure that sensitive minority and low-income communities were considered in their decision-making processes and they acknowledged, “Historically, overburdened communities have experienced higher levels of environmental pollution within their community along with other social and economic burdens.”²

As a result of this EO, in 2007, the South Carolina General Assembly passed Act 171 to create an S. C. Environmental Justice Advisory Committee within SC DHEC. The Committee was formed and tasked with identifying existing practices at state agencies regarding environmental justice issues, assessing how they impact economic development and revitalization projects, and making recommendations. As a result, a study was taken of the current landscape and among the key findings were: “Allowing poor communities to have a say in stopping undesirable development [is necessary to revitalize distressed areas],” “Policy makers often ignore community input, especially that given by poor and African American community members” and “When relocating communities using eminent domain the residents aren’t given a fair price.” *See* South Carolina Environmental Justice Advisory Committee Final Report.³ The goal of Executive Order 12,898, however, has not been met, and on January 20, 2021, the Biden administration called for a review of Nationwide Permits consistent with its Executive Order PROTECTING PUBLIC HEALTH AND THE ENVIRONMENT AND RESTORING SCIENCE TO TACKLE THE CLIMATE CRISIS.⁴ This directive, in relevant part, specifically calls out those “who disproportionately harm communities of color and low-income communities.” *Id.*

The area where Dominion proposes to place this pipeline is one of the exact areas that should be given greater scrutiny under the EOs. Dominion claims without proof that this “proposed project is expected to have a positive impact on minority populations due to the creation of jobs,” but does not discuss other negative impacts to minority populations, including those stemming

¹ <https://www.epa.gov/environmentaljustice>

² <https://scdhec.gov/history-ej>

³ <https://scdhec.gov/sites/default/files/media/document/EJAdvisoryFinalReportCombined.pdf>

⁴ <https://www.whitehouse.gov/briefing-room/presidential-actions/2021/01/20/executive-order-protecting-public-health-and-environment-and-restoring-science-to-tackle-climate-crisis/>

from cumulative adverse effects to WOTUS. See **Exhibit B** (Dominion’s Application materials), p. 33 To explore those effects in the words of those who will be affected, we direct you to the comments BREDL submitted about the project to the Public Service Commission. Those comments are also incorporated and attached to this letter as **Exhibit C**. As set forth in the letter, there already are moderate to high levels of social vulnerability in the census tracts in the Pamplico area of Florence County and the letter contains several first-person testimonials from citizens in the area discussing the ways they will be impacted by this pipeline. As the state’s environmental regulator and a recipient of federal funding, DHEC is required to ensure that environmental justice communities are considered throughout its decision-making processes. Simply stated, denying Dominion’s application here is an opportunity for both the Corps and DHEC to ‘walk their talk’ on environmental justice.

C. **Statutory Framework**

Congress recognized the essential role that States must play in protecting their own waters. Congress enacted the Clean Water Act in part to “recognize, preserve, and protect the primary responsibilities and rights of States to prevent, reduce, and eliminate pollution, to plan the development and use (including restoration, preservation, and enhancement) of land and water resources.” *Sierra Club v. U.S. Army Corps of Eng’rs*, 909 F.3d 635, 647 (4th Cir. 2018) (quoting 33 U.S.C. § 1251(b)) (*emphasis omitted*); see also *Piney Run Pres. Ass’n v. Cnty. Comm’rs of Carroll Cnty.*, 268 F.3d 255, 265 n.9 (4th Cir. 2001) (“Under the CWA, states have the primary role in promulgating water quality standards.”). South Carolina exercises this authority through DHEC. The Department, in turn, has promulgated various State water quality standards. One standard, the State’s Antidegradation Policy, included Antidegradation Rules in Section D of S.C. Regulation 61-68, Water Classifications and Standards, which provide in part that “existing water uses and the level of water quality necessary to protect these existing uses shall be maintained and protected regardless of the water classification.” S.C. Code Ann. Regs. 61-68(D)(1).

Under section 401 of the Clean Water Act, an applicant for a federal license or permit for activity that “may result in any discharge into the navigable waters”—such as an applicant for a section 404 dredge-and-fill permit or for a certificate of public convenience and necessity under the Natural Gas Act—must receive a water quality certification: state certification that “any such discharge will comply with the applicable provisions of sections [301–303 and 306–307 of the Clean Water Act].”⁵ As to water quality certification, EPA regulations specify that a water quality certification must include “[a] statement that there is a reasonable assurance that the activity [for which a water quality certification application has been submitted] will be conducted in a manner which will not violate applicable water quality standards.”⁶ Notably, states may generally regulate water quality more stringently than as required by the Clean Water Act.⁷ Section 401(d) provides additionally that states shall attach conditions to water quality certifications in the form of “effluent

⁵ 33 U.S.C. § 1341(a)(1). These sections of the Clean Water Act include provisions relating to standards, limitations, and prohibitions for point source discharges, and also relating to state-promulgated water quality standards. 33 U.S.C. §§ 1311–13, 1316–17.

⁶ 40 C.F.R. § 121.2(a)(3).

⁷ 33 U.S.C. § 1370. EPA regulations note that this non-preemption clause is applicable to water quality standards. 40 C.F.R. § 131.4(a) (“As recognized by section 510 of the Clean Water Act, States may develop water quality standards more stringent than required by [the EPA water quality standards] regulation.”).

limitations and other limitations, and monitoring requirements” necessary to assure compliance with the applicable requirements of sections 301– 303 and 306–307 of the Clean Water Act, “and with any other appropriate requirement of State law set forth in [the water quality certification].”⁸

Under section 401 of the Clean Water Act, South Carolina must determine whether or not “any such discharge [arising from the project] will comply” with applicable water quality requirements. 33 U.S.C. § 1341(a)(1). Thus, DHEC’s 401 Water Quality Certification program requires that the agency consider all potential water quality impacts of the project, both direct and indirect, over the life of the project including:

- (a) Whether the activity is water dependent and the intended purpose of the activity;
- (b) Whether there are feasible alternatives to the activity;
- (c) All potential water quality impacts of the project, both direct and indirect, over the life of the project including:
 - (1) Impact on existing and classified water uses;
 - (2) Physical, chemical, and biological impacts, including cumulative impacts;
 - (3) The effect on circulation patterns and water movement;
 - (4) The cumulative impacts of the proposed activity and reasonably foreseeable similar activities of the applicant and others. S.C. Code Regs. R. 61-101(F)(3)(c).

Further, the regulations explicitly state that certification **will** be denied if: (a) the proposed activity permanently alters the aquatic ecosystem in the vicinity of the project such that its functions and values are eliminated or impaired; or (b) there is a feasible alternative to the activity, which reduces adverse consequences on water quality. S.C. Code Regs. 61-101.F.5. Notably, Dominion need only fail to demonstrate compliance with one water quality standard in order for the Department to properly deny water quality certification for the Project. In this case, as outlined below, Dominion has failed to demonstrate compliance with all of the standards.

D. Whether the activity is water dependent and the intended purpose of the activity

Despite their assertions otherwise, Dominion Energy failed to adequately assess the project’s feasible alternatives. In their materials, Dominion completely fails to seriously consider less-damaging plans, let alone demonstrate that there are no less damaging feasible alternatives. A practicable alternative is one that “is available and capable of being done after taking into consideration cost, existing technology, and logistics in light of overall project purposes.” Their position ignores that when a project “is not water dependent” a presumption arises that there are “practicable alternatives [available] that do not involve special aquatic sites” and that “have less adverse impact on the aquatic ecosystem, unless clearly demonstrated otherwise.” 40 C.F.R. § 230.10(a)(2)-(3);

This proposed project is not water dependent. Dominion admits as much on p. 13 of **Exhibit B** in its Section 404 Individual Permit Application. Dominion Energy has determined the

⁸ 33 U.S.C. § 1341(d). Although this provision does not mention section 303, the Supreme Court has held that the reference to section 301 incorporates section 303 by reference, making water quality standards a permissible consideration in setting conditions under section 401(d). *PUD No. 1 of Jefferson Cty. v. Wash. Dep’t of Ecology*, 511 U.S. 700, 712–13 (1994).

basic purpose of the proposed project is to install a gas main to support the growth in the area and the overall purpose of the proposed project is to provide natural gas utilities in Florence County, South Carolina for developments requiring natural gas as an energy supply. See **Exhibit B**, p. 12. Where an activity associated with a discharge which is proposed for a special aquatic site (as defined in subpart E) does not require access or proximity to or siting within the special aquatic site in question to fulfill its basic purpose (i.e., is not “water dependent”), practicable alternatives that do not involve special aquatic sites are presumed to be available, unless clearly demonstrated otherwise. In addition, where a discharge is proposed for a special aquatic site, all practicable alternatives to the proposed discharge which do not involve a discharge into a special aquatic site are presumed to have less adverse impact on the aquatic ecosystem, unless clearly demonstrated otherwise. 40 C.F.R. § 230.10(a)(3).

E. Whether there are feasible alternatives to the activity

DHEC has an obligation to determine whether the stated purpose of the Project could be served by less environmentally damaging alternatives. Instead of rebutting the water-dependency presumption as required, Dominion focused on offsite alternatives with the same constrained project purpose in an attempt to foreclose all other alternative sites or less-damaging alternative development designs. 40 C.F.R. 230.10(a)(3) would be meaningless if a project could be defined so narrowly as to require the development of a particular wetland. See *Sierra Club v. Van Antwerp*, 526 F.3d 1353, 1367 (11th Cir.2008) (Kravitch, J., dissenting) (“A project is not water-dependent simply because an applicant asks to do it on wetlands, but only where it literally cannot be done elsewhere.”).

Try as they may, Dominion cannot define the project in order to preclude the existence of any alternative sites and thus make what is practicable appear impracticable; yet, in an attempt to do exactly that, Dominion claims the factors for its site selection criteria are listed in order of priority as: (1) Location within an existing easement; (2) Ability to acquire agreements for easements; (3) Ability to avoid permanent clearing impacts; (4) Distance from River Neck Road Regulating Station to Kingsburg Valve Station; and (5) Readily accessible. See **Exhibit B**, at p. 14 (2.2.1 *Site Selection Criteria* and 2.2.1.2 *Ability to Acquire Agreements for Easements*).

As to criteria 1 and 2, “Location within an existing easement,” and “Ability to acquire agreements for easements,” respectively, Dominion claims without explanation that “Conformance with this criterion would result in avoidance of new impacts to sensitive resources and other indirect environmental impacts associated with obtaining new easements” and “Constraints regarding owner agreements and easement terms were also a contributing factor for the applicant’s section process.” *Id.* This statement seems to incorrectly suggest that both the existing easements *are not* located in the vicinity of sensitive resources and any new easements *are* located in the vicinity of sensitive resources. Moreover, there is a question as to whether the alternative sites were adequately assessed before being tossed as failing to meet the threshold analysis of being the Least Environmentally Damaging Alternative (LEDPA). The wetlands that will be impacted by the Project are not classified correctly, are not fully assessed in terms of uses and functions, and therefore it cannot be concluded by the Department that there will be no adverse impacts to the waters or wetlands. See **Exhibit B**, at p. 16 (“Terracon in no way claims to have specialized knowledge of the aquatic features on the alternative sites evaluated. Each alternative

site should be reviewed independently for potential aquatic resources and reviewed by applicable regulatory agencies to determine the presence and extent of aquatic resources as applicable and required by Section 404 of the Clean Water Act.”). Because even the consultants performing the alternatives analysis did not take the aquatic features/resources into account when ruling out alternatives, this project should be denied approval.

An alternative site does not have to accommodate components of a project that are merely incidental to the applicant’s basic purpose. For example, in *Shoreline Assocs. v. Marsh*, 555 F.Supp. 169, 179 (D.Md.1983), *aff’d*, 725 F.2d 677 (4th Cir.1984), the Corps refused to issue a permit to a developer for building a number of waterfront town houses together with a boat storage and launching facility. The developer argued that the Corps’ proposed alternative site for the town houses could not accommodate the boat storage and launch area. The court upheld the Corps’ denial of the permit, observing that the boat facilities were merely “incidental” to the town house development. *Id.* The same is true here; DHEC cannot allow incidental easement agreements to drive an improper characterization of purpose that serves to constrain the evaluation of alternatives. See **Exhibit B**, at p. 14 (2.2.1 *Site Selection Criteria* and 2.2.1.2 *Ability to Acquire Agreements for Easements*). It is well-settled that “[t]he cumulative destruction of our nation’s wetlands that would result if developers were permitted to artificially constrain the alternatives analysis by defining the project’s purpose in an overly narrow manner would frustrate the statute and its accompanying regulatory scheme.” *Nat’l Wildlife Fed’n v. Whistler*, 27 F.3d 1341, 1346 (8th Cir. 1994). Because Dominion failed to adequately assess the project’s feasible alternatives, the project should be denied.

F. All potential water quality impacts of the project, both direct and indirect, over the life of the project

The Clean Water Act “requires each State, subject to federal approval, to institute comprehensive water quality standards establishing water quality goals for all intrastate waters.” *PUD No. 1 of Jefferson Cnty.*, 511 U.S. at 700, 114 S.Ct. 1900. While a State’s authority under the Clean Water Act “is not unbounded,” *id.* at 712, 114 S.Ct. 1900, the Supreme Court recognizes that a State’s antidegradation rules—rules to maintain existing, beneficial uses of water—are appropriate requirements under the Clean Water Act. *see also* Env’tl. Prot. Agency, EPA-841-B-05-003, National Management Measures to Protect and Restore Wetlands and Riparian Areas for the Abatement of Nonpoint Source Pollution (2005) (explaining how “[w]etlands and riparian areas play a significant role in protecting water quality and reducing adverse water quality impacts”). Pipeline construction can impact both surface and groundwater resources utilized by public water providers and private drinking water wells. Here, Dominion proposes impacts to 32 separate wetlands or waters, including:⁹

- Twenty-seven (27) temporary excavation impacts totaling 8.378 acres;
- Twenty-nine (29) permanent clearing impacts totaling 2.990 acres;
- Three (3) permanent fill impacts totaling 0.009 acres;
- Nine (9) temporary clearing impacts totaling 6.337 acres

⁹ DHEC’s 401 Water Quality Certification is not certified for pipelines with more than 10 aquatic site crossings or activities that cause the loss of more than 300 linear feet of stream bed.
<https://scdhec.gov/sites/default/files/media/document/NODD%20NWP%202020.pdf>

WETLAND ID	IMPACT #	TEMPORARY IMPACT (ACRES / LF)		PERMANENT CLEARING IMPACT (ACRES / LF)		PERMANENT FILL IMPACT (ACRES / LF)		TEMPORARY CLEARING IMPACT (ACRES / LF)		WETLAND TYPE	ACREAGE	FEET
B	1	0.110	0.00	0.030	0.00	0.000	0.00	0.000	0.00	WETLAND	0.140	0.00
A	2	5.140	0.00	1.800	0.00	0.000	0.00	5.640	0.00	WETLAND	12.580	0.00
C	3	0.000	0.00	0.060	0.00	0.000	0.00	0.020	0.00	WETLAND	0.080	0.00
D	4	0.000	0.00	0.125	0.00	0.000	0.00	0.000	0.00	WETLAND	0.125	0.00
E	5	0.000	0.00	0.089	0.00	0.000	0.00	0.000	0.00	WETLAND	0.089	0.00
F	6	0.490	0.00	0.120	0.00	0.000	0.00	0.310	0.00	WETLAND	0.920	0.00
G	7	0.270	0.00	0.094	0.00	0.000	0.00	0.140	0.00	WETLAND	0.504	0.00
AA	8	0.180	0.00	0.042	0.00	0.000	0.00	0.000	0.00	WETLAND	0.222	0.00
BB	9	0.013	0.00	0.017	0.00	0.000	0.00	0.000	0.00	WETLAND	0.030	0.00
CC	10	0.007	0.00	0.014	0.00	0.000	0.00	0.000	0.00	WETLAND	0.021	0.00
DD	11	0.020	0.00	0.036	0.00	0.000	0.00	0.000	0.00	WETLAND	0.056	0.00
EE	12	0.011	0.00	0.015	0.00	0.000	0.00	0.000	0.00	WETLAND	0.026	0.00
FF	13	0.160	0.00	0.040	0.00	0.000	0.00	0.000	0.00	WETLAND	0.200	0.00
GG	14	0.008	0.00	0.005	0.00	0.000	0.00	0.000	0.00	WETLAND	0.013	0.00
HH	15	0.130	0.00	0.014	0.00	0.000	0.00	0.000	0.00	WETLAND	0.144	0.00
II	16	0.017	0.00	0.005	0.00	0.000	0.00	0.016	0.00	WETLAND	0.038	0.00
JJ	17	0.410	0.00	0.100	0.00	0.000	0.00	0.000	0.00	WETLAND	0.510	0.00
KK	18	0.040	0.00	0.007	0.00	0.000	0.00	0.000	0.00	WETLAND	0.047	0.00
TRIBUTARY LL	19	0.019	78.00	0.002	11.00	0.0045	22.00	0.008	27.00	NON-WETLAND WATERS	0.034	138.00
MM	20	0.140	0.00	0.030	0.00	0.000	0.00	0.000	0.00	WETLAND	0.170	0.00
NN	21	0.170	0.00	0.050	0.00	0.000	0.00	0.000	0.00	WETLAND	0.220	0.00
H	22	0.190	0.00	0.050	0.00	0.000	0.00	0.120	0.00	WETLAND	0.360	0.00
I	23	0.120	0.00	0.040	0.00	0.000	0.00	0.000	0.00	WETLAND	0.160	0.00
J	24	0.060	0.00	0.020	0.00	0.000	0.00	0.000	0.00	WETLAND	0.080	0.00
K	25	0.250	0.00	0.070	0.00	0.000	0.00	0.000	0.00	WETLAND	0.320	0.00
L	26	0.150	0.00	0.050	0.00	0.000	0.00	0.080	0.00	WETLAND	0.280	0.00
TRIBUTARY SS	27	0.009	41.00	0.002	10.00	0.000	0.00	0.003	26.00	NON-WETLAND WATERS	0.014	77.00
RR	28	0.044	0.00	0.013	0.00	0.000	0.00	0.000	0.00	WETLAND	0.057	0.00
QQ	29	0.030	0.00	0.000	0.00	0.000	0.00	0.000	0.00	WETLAND	0.030	0.00
OO	30	0.190	0.00	0.050	0.00	0.000	0.00	0.000	0.00	WETLAND	0.240	0.00
C (5-28)	31	0.000	0.00	0.000	0.00	0.0017	0.00	0.000	0.00	WETLAND	0.002	0.00
D (5-28)	32	0.000	0.00	0.000	0.00	0.0024	0.00	0.000	0.00	WETLAND	0.002	0.00
Total	--	8.378	119.00	2.990	21.00	0.009	22.00	6.337	53.00	--	17.714	193.00

See **Exhibit B**, at pp. 7, 72. The upper portion of the project site is located within Watershed 03040201-09. In this watershed, Jeffries Creek, Pye Branch, and Middle Swamp are classified as FW* (dissolved oxygen not less than 4 mg/l and pH between 5.0 and 8.5) and the remaining streams in the watershed are classified as FW (Freshwater). The majority of the project site is located in the Great Pee Dee River Watershed (03040201-12) where all waters are classified as FW. Jeffries Creek and Great Pee Dee River are listed on the 2016 South Carolina List of Impaired Waters by 12-Digit HUC. As to the Jeffries Creek impacts, the application notes: “At station PD-231, aquatic life and recreational uses are fully supported; however, there are trends in significant decrease in dissolved oxygen concentrations as well as trends in increasing five-day biological oxygen demands, turbidity, and fecal coliform bacteria.” **Exhibit B**, at p. 31. As to the Great Pee Dee River Watershed, the application notes “Dissolved oxygen excursions occurred; however, they are typical values seen in blackwater systems and were considered natural (not standard violations).” **Exhibit B**, at p. 31. South Carolina’s Antidegradation Policy provides that “existing water uses and the level of water quality necessary to protect these existing uses shall be maintained and protected regardless of the water classification.” S.C. Code Ann. Regs. 61-68(D)(1).

The application acknowledges these impacts, claiming they will be “minimized through the use of stormwater best management practices” but does not elaborate on these practices to an extent that should assure DHEC those practices will be followed. **Exhibit B**, at p. 22. The application also does not consider the direct and indirect impacts of constructing this pipeline in the middle of a floodplain. See **Exhibit B**, at p. 26 (“According to the Federal Emergency Management Administration (FEMA) Flood Insurance Rate Map (FIRM), the site is located within a designated floodplain or a floodway.”) Additionally, the applicant claims its land

disturbance activity will comply with the South Carolina National Pollutant Discharge Elimination System (NPDES) General Permit for Storm Water Discharges from Large and Small Construction Activities (SCR100000) as applicable and will include the use of appropriate grading and sloping techniques and erosion prevention and sediment control measures capable of preventing erosion, migration of sediments, and bank failure. This is also untrue.¹⁰

Moreover, the “temporary” qualification of the impacts hinges on the methods that will be used to protect the wetlands during construction and the restoration of the wetlands after construction. BREDL does not have confidence in the capability of avoiding permanent damage using the methods proposed. The Corps notes over and over those certain provisions in NWP 12 will require permittees to ensure their activities “will result in only temporary impacts.” 85 Fed. Reg. at 57,325. The Corps asserts that NWP 12 requires that temporary fills be restored to pre-construction elevations and revegetated as appropriate and Dominion claims—without detail—that the “[i]mpacted areas will be restored to pre-existing contours. Upland areas shall be restored through typical right-of-way practices of seeding and mulching as described in the reclamation plan for the project.” See **Exhibit B**, at p. 84. However, there is no detailed explanation of when or how this will take place and NWP 12’s own general conditions suggest that clearing forested wetlands will have permanent—not temporary—impacts.¹¹ In its NWP 12 decision document, the Corps notes that:

For the construction or maintenance of oil or natural gas pipelines impacts to wetlands are often temporary, *unless the site contains forested wetlands* that are [cleared and] not allowed to regenerate because of maintenance of the pipeline right-of-way or because of permanent fills in wetlands.

Id; see also **Exhibit B**, at p. 9 (“The wooded land on the site consists of a combination of mixed pine-hardwood forest and forested wetlands.”). It can reasonably be expected that these construction activities will not result in temporary but permanent impacts on the wetlands in a multitude of ways. Construction activity and machinery and foot traffic cause compaction that can be and often is permanent, even if mats and fabric techniques are employed. There is no evidence of soil testing to measure current soil conditions to ensure that restoration restores the soil structure and pore spaces that are essential for wetland ecosystems and functions and that compaction does not occur. See **Exhibit B**, at p. 84 (“Restoration of wetlands may vary depending on the extent of disturbance to the upper soil layer and vegetation during the initial IR response.”). There will undoubtedly be a permanent elimination of bird watching, hunting, and fishing in discharge areas, as well as adverse effects to the movement of water in the aquatic environment. This change in stream flow, flooding patterns, and surface and groundwater hydrology, which in turn may

¹⁰ Compare NPDES General Permit for Stormwater Discharges from Construction Activities (SCR100000) available at https://scdhec.gov/sites/default/files/media/document/BOW_NPDESStormwaterDischargesGP_01292021_0.pdf (“If BMPs are not operating effectively, then maintenance must be performed **within seven (7) calendar days** or as reasonably possible, and before the next storm event whenever practicable to maintain the continued effectiveness of BMPs.”) with **Attachment B**, p. 84 (“Drilling fluid releases that persist beyond completion of drilling activities shall be removed **within 30 days** of completion of drilling, if requested by the Federal or State regulatory agencies having jurisdiction.”) (emphasis added). Inadvertent returns (IRs) from HDD at river crossings can introduce polluted water into streams and rivers being crossed and it is ridiculous that the onus would be on DHEC or other regulatory agencies to request cleanup of a drilling fluid release weeks after the pollution.

¹¹ See <https://usace.contentdm.oclc.org/utls/getfile/collection/p16021coll7/id/16834>

adversely affect populations of fish and other aquatic animals, should be considered permanent and the application should be denied.

At a minimum, Dominion Energy's safety record demonstrates that this project could pose serious risks to the environment and citizens. On November 15, 2019 at approximately 1:00 a.m., one of Dominion Energy's newly installed gas lines exploded at Pepper Pike¹² in Ohio. An investigation by the Public Utilities Commission of Ohio (PUCO) resulted in a report issued February 28, 2020, revealing that the cause of the explosion and resulting fire was Dominion Energy's "failure to follow established welding procedures, insufficient inspection and oversight at the construction site, and lack of procedures and training regarding auger boring, which led to the pipeline being subject to excessive strain." *Id.* In detail, the report states:

Staff believes Dominion showed a **lack of institutional control at the construction project** located at Shaker Blvd. in Pepper Pike. **Poor construction practices, failure to follow established procedures, and a lack of oversight all contributed** to the weld failure and pipeline rupture. Staff further believes that the number of bad welds found at the site, **Dominion's previous enforcement history related to not following or enforcing procedures in the field, and poor documentation practices** show that failures similar to the pipeline rupture in Pepper Pike **may recur in the future** if the factors that contributed to the rupture are not addressed....Finally, given the severity of the violations, Staff recommends that a forfeiture of \$2,500,000 be assessed pursuant to O.R.C. 4905.95(B)(1)(b) against Dominion Energy Ohio for failure to comply with Pipeline Safety Regulations requirements that caused or contributed to this incident. **This incident posed a serious danger to the public. Given the destruction that it caused and the location, if this had happened during a period of high traffic, instead of at 1:00am, the likelihood that someone would have been injured or killed would have been significantly higher.**

Id.

In March of last year, Dominion Energy was forced to pay \$1.4 million in fines after violating numerous state and federal environmental laws after secretly and illegally dumping more than 27 million gallons of polluted coal ash water into Quantico Creek in Virginia.¹³ Confronted with the discharge, Dominion Energy insisted the discharge was made in compliance with its Clean Water Act permit; however, an investigation showed that was not the case.

Dominion's violations are not just national, however. In 2018, Dominion was cited for failing to control sediment near a 55-mile pipeline it had built in the upstate of South Carolina.¹⁴ Sediment washing off the pipeline's construction sites wound up in creeks that feed into the South Tyger River, where the Woodruff-Roebuck Public Water District has an intake pipe. The runoff from Dominion's construction also worked its way into the river and clogged the pipe, causing the

¹² <http://dis.puc.state.oh.us/CaseRecord.aspx?CaseNo=19-2140&x=0&y=0>

¹³ <https://www.oag.state.va.us/media-center/news-releases/1657-march-13-2020-dominion-to-pay-1-4-million-for-alleged-violations-of-virginia-s-environmental-laws-and-regulations;> *see also* <https://files.constantcontact.com/bfcd0cef001/228a429a-f207-495f-b608-519ff30fa7d9.pdf>

¹⁴ <https://abcnews4.com/news/local/south-carolina-fines-dominion-energy-for-polluting-drinking-water>

Woodruff-Roebuck system to buy water from another utility for more than 10,000 customers south of Spartanburg.¹⁵ Ultimately, a \$4,200 fine was issued by DHEC which Dominion Energy later stated had “minimal impact.”¹⁶ Here, City of Florence drinking water is produced at a surface water treatment facility that withdraws water from the Great Pee Dee River, which runs along the proposed pipeline.

Because failure of erosion and sediment controls due to improper installation or insufficient maintenance—as well as a lack of approved erosion and sediment control best management practices—have been major sources of violations for Dominion in the past, increased scrutiny should be applied to its current proposal. Increased sedimentation and turbidity resulting from in-stream and adjacent construction activities could displace and impact fisheries and aquatic resources. Sedimentation could smother fish eggs and other benthic biota and alter stream bottom characteristics, such as converting sand, gravel, or rock substrate to silt or mud. These habitat alterations could reduce juvenile fish survival, spawning habitat, and benthic community diversity and health. Increased turbidity could also temporarily reduce dissolved oxygen levels in the water column and reduce respiratory functions for in-stream biota. Turbid conditions could also reduce the ability for biota to find food sources or avoid prey. Benthic invertebrates and freshwater mussels could also be affected by elevated turbidity and suspended sediments. Aquatic invertebrates, including insect larvae, would generally be unable to avoid work areas. Considering Dominion Energy’s construction practices and procedures and its history of damaging South Carolina’s water supply, the applicant’s activities are nearly certain to cause sedimentation and turbidity, alteration or removal of instream and stream bank cover, stream bank erosion, introduction of water pollutants, water depletions, and entrainment of small fishes during water withdrawals that could increase the rates of stress, injury, and mortality experienced by fish and other aquatic life. For these reasons, Dominion’s application should be denied.

G. The proposed activity permanently alters the aquatic ecosystem in the vicinity of the project such that its functions and values are eliminated or impaired.

The wetlands that will be impacted, whether by impacts qualified as temporary or permanent, will suffer unjustifiable harm that will permanently harm the ecosystem. Proof of this can be found by looking no further than Dominion’s application materials. See **Exhibit B**, at p. 34 (“The construction of this project will have a minimal long-term adverse effect on wildlife that use the habitat.”). Regulation 61–101 states, “Certification will be denied if (a) the proposed activity permanently alters the aquatic ecosystem in the vicinity of the project such that its functions and values are eliminated or impaired.” S.C. Code Ann. Regs. 61–101.F.5(a). The conversion of forested/shrub wetlands has lasting and devastating impacts. The applicant baldly asserts that some activities associated with the project will not result in permanent impacts to wetlands, and that wetlands will be restored to pre-existing conditions. This is impossible given that trenching activities would require the permanent removal of vegetation and result in a decrease in water quality. The permanent impacts to wetlands require mitigation or replacement but the applicant does not address this requirement whatsoever.

¹⁵<https://www.greenvilleonline.com/story/news/2018/05/25/dominion-energy-under-scrutiny-after-mud-clogs-water-system-near-utility-sc-project/645320002/>

¹⁶ <https://www.dominionenergy.com/library/domcom/media/community/environment/reports-performance/water-cdp-2018.pdf?la=en&modified=20191021165021>

Horizontal directional drilling (HDD)—a stream crossing method in which a tunnel to house the pipeline is drilled underneath a surface water, road, or other feature—is often touted as having minimal impacts to surface waters; however, this method is not without risk; drilling fluid spills and runoff from work areas pose threats to waterways. This is acknowledged even by Dominion, who acknowledges the risk of adverse impacts to aquatic ecosystem. **Exhibit B**, at p. 78 (“these drilling fluids may adversely impact aquatic and/or terrestrial ecosystems if an IR occurs.”) Drilling fluid is composed of bentonite, water, and additives chosen by the company from a list of approved compounds that can be used when drilling public water supply wells. Though bentonite is a type of natural clay, releasing it into streams and wetlands can increase sediment in those areas. BMPs for prevention of water pollution may not properly prevent contamination events for a number of reasons, such as the correct BMPs were planned, but were not installed correctly or at all; inappropriate BMPs were installed, or BMPs were inadequate for the conditions; or BMPs were improperly operated and maintained. In addition to these permanent and temporary impacts, wetland crossings can result in conversions from forested to either scrub-shrub or herbaceous wetlands, which will nearly always result in a loss of important wetland functions.

CONCLUSION

The applicant has not met its burden on demonstrating why this proposal meets both the Corps’ and DHEC’s guidelines to warrant approval and for the reasons set forth above, we urge the Corps of Engineers and DHEC to the extend the public comment period, schedule a hearing for public comment on the above-referenced permit when the public can attend and ultimately deny the above-referenced application or, at a minimum, require applicant modify its application to reduce or eliminate aquatic impacts to the fullest extent possible. We request notification of any action or decision related to this project, preferably via email to lauren@scelp.org. Thank you for your consideration of these important issues.

Sincerely,



Lauren Megill Milton

LMM/lmm

cc: Lou Zeller

Enclosures:

Exhibit A: BREDL’s previous comments to the Corps and DHEC dated July 6, 2020

Exhibit B: Dominion Energy’s application materials

Exhibit C: BREDL’s comments to the PSC dated June 11, 2021

EXHIBIT A



South Carolina Environmental Law Project

Lawyers for the Wild Side of South Carolina

July 6, 2020

a 501c3
non-profit organization

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Re: River Neck to Kingsburg 16 Inch Gas Main Florence County, South Carolina
P/N: SAC-2019-01427

Dear Corps and DHEC Staff,

The South Carolina Environmental Law Project (SCELP), on behalf of Blue Ridge Environmental Defense League, writes in opposition to the above-referenced application for a permit to install a 14.5-mile gas main pipeline. SCELP is a non-profit public interest law firm dedicated to the protection of South Carolina's environment and we submit this letter on behalf of Blue Ridge Environmental Defense League, a regional, non-profit, community-based organization founded on earth stewardship, environmental democracy, social justice, and community empowerment.

We appreciate the opportunity to comment on the Kingsburg 16 Inch Gas Main public notice of application for a permit under Section 404. This letter is intended to pertain to all forthcoming permitting processes for the project that are relevant to the subjects this letter addresses and is in addition to any separate comment letters this group may submit.

I. PROJECT BACKGROUND

The proposed work consists of installing a 14.5 mile, 16 inch gas main by trench and backfill, widening portions of the Right of Way (ROW) easement by 10 feet, and the installation of a permanent roadway crossing of a tributary with a culvert to retain hydrological flow. In detail, the gas main will pass through twenty-seven (27) jurisdictional wetlands and two (2x) tributaries. The project seeks to temporarily impact 7.083 acres of wetlands with temporary clearing impacts for site preparation, 8.908 acres of wetlands with temporary excavation and backfill impacts for the installation of the gas main, 0.004 acres of tributaries with permanent fill impacts for the creation of a roadway crossing with associated

culvert, and 2.519 acres of wetlands with permanent clearing and conversion of land from forested wetlands to emergent wetlands. The applicant has proposed to mitigate for impacts to wetlands and/or waters of the United States by purchasing 12.7 mitigation credits from a third-party mitigation bank. As stated by the applicant, the project purpose is “to support the development of a gas main installation referred to as River Neck to Kingsburg 16” Gas Main.”

II. REQUEST FOR PUBLIC HEARING

For the reasons set forth in detail throughout this comment letter, commenters hereby request a public hearing on this pipeline project. The Clean Water Act provides in its general policy section that “public participation in the development ... of any ... program established by the Administrator... under this chapter shall be provided for, encouraged, and assisted by the Administrator ...” 33 U.S.C. § 1251(e). Section 404 states: “[t]he Secretary may issue permits, after notice *and opportunity for public hearings* for the discharge of dredged or fill material into the navigable waters at specified disposal sites.” 33 U.S.C. § 1344(a) (emphasis added). Corps regulations further state: “[A]ny person may request, in writing,...that a public hearing be held....Requests for a public hearing under this paragraph shall be granted, unless the district engineer determines that the issues raised are insubstantial or there is otherwise no valid interest to be served by a hearing.” 33 C.F.R. § 327.4(b). “In case of doubt, a public hearing shall be held.” 33 C.F.R. § 327.4(c).

Approval of a massive gas pipeline through South Carolina without holding a public hearing would violate the Corps’ Clean Water Act mandate to involve the public and hold a public hearing. Indeed, there are substantial issues of significant consequence being raised by affected community members and the public at-large, and described below, demonstrating a valid interest in holding a public hearing. The Corps would violate the CWA’s clear mandate to involve the public and allow public hearings if it approves a massive pipeline without holding a public hearing related directly to the federal approval process for the CWA 404 permit.

Additionally, given the circumstances of the COVID-19 pandemic, and recent recommendations and orders from the Center for Disease Control, local public health departments, Governor McMaster, and other epidemiological experts recommending that sick, elderly and other vulnerable populations self-isolate, we request that any public hearing be scheduled only after confirmation that the risk of transmission has subsided. This is especially critical for individuals who are affected by the proposed project and are vulnerable or at high-risk for serious illness from COVID-19. The COVID-19 pandemic has led to office and school closures throughout the country. As a result, members of the public, as well as attorneys and support staff at organizations engaged in this project are forced to make necessary adjustments, including alternative childcare arrangements, to coordinate offsite preparation and timely filing of comments. In many cases, this has led to insufficient time for review and comment preparation on the 404 application and under the current deadlines. As such, the undersigned request that the Corps provide a 30-day extension on the deadline for comment.

III. THE PROJECT DOES NOT COMPLY WITH SECTION 404 OF THE CLEAN WATER ACT

The Clean Water Act has the sweeping goals to “restore and maintain the chemical, physical, and biological integrity of the Nation’s waters,” 33 U.S.C. § 1251(a), and “to increase

the quality and quantity of the Nation’s wetlands,” *Id.* § 2317(a). The Act prohibits the discharge of soil or other materials into wetlands unless authorized by a permit issued by the Corps, 33 U.S.C. § 1344(a); 33 C.F.R. § 322.3; Parts 323, 325, and provides strict substantive limits on approving projects that degrade water quality or harm aquatic uses. The Corps must deny the permit because the proposed discharge does not comply with the CWA’s Section 404(b)(1) guidelines. The Clean Water Act limits the authority of the Corps to issue permits for the discharge of fill material into the waters of the United States.¹

Specifically, Section 404(b)(1) of the CWA requires the Corps to apply guidelines established by the U.S. Environmental Protection Agency (“EPA”) to restore and maintain the integrity of aquatic ecosystems. 33 U.S.C. § 1344(b)(1); 40 C.F.R. § 230.1(a). The Corps’ regulations state that a permit will be denied if the proposed discharge would not comply with the 404(b)(1) guidelines. 33 C.F.R. § 323.6(a). Under these guidelines, “degradation or destruction of special aquatic sites, such as filling operations in wetlands, is considered to be among the most severe environmental impacts.” 40 C.F.R. § 230.1(d). Discharging fill material in wetlands often destroys habitat and vegetation, degrades water quality, and diminishes wetlands’ capacity to store floodwater and shield upland areas from erosion. *Id.* § 230.41(b). “Fundamental to [the 404(b)(1)] Guidelines is the precept that...fill material should not be discharged into the aquatic ecosystem, unless it can be demonstrated that such a discharge will not have an unacceptable adverse impact.” *Id.* § 230.1(c). Discharging fill material into waters of the United States violates the Section 404(b)(1) guidelines when (1) there is a practicable alternative that would have less adverse effect on the aquatic ecosystem; (2) the proposed filling would significantly degrade the aquatic ecosystem; or (3) the proposed filling does not include all appropriate and practicable measures to minimize potential harm to the aquatic ecosystem. *See Id.* § 230.12(a)(3)(i)–(iii); *see also Id.* § 230.10(a), (c), (d). If there remain unavoidable impacts, the Corps must decide what compensatory mitigation is required. *Id.* § 230.93(a)(1).

In applying the above criteria, the Corps must make detailed factual determinations as to the potential environmental effects of the proposed discharges. *See Id.* §§ 230.11, 230.12(b). Crucially, these factual determinations depend on not only a project’s direct effects on aquatic ecosystems, but also the cumulative effects of other discharges and secondary effects associated with the project. *See Id.* § 230.11(g), (h). Thus, while the Section 404(b)(1) guidelines apply only to the waters of the United States and coextensive aquatic ecosystems, *see Id.* § 230.3(b), the Corps must consider the environmental impacts from additional predictable developments, as well as those indirectly caused by a project. In making these factual determinations, the Corps must evaluate the duration and physical extent of any impacts as well as the possible loss of environmental values for different waters. *E.g., Id.* § 230.11.

There are several specific requirements under the Section 404(b)(1) guidelines that are particularly relevant here. First, the Corps may not issue a permit under Section 404 if there is any “practicable alternative” to the project with less impact on the aquatic ecosystem. 40 C.F.R. § 230.10(a). Second, no discharge can be permitted that jeopardizes the continued existence of species listed as endangered or threatened under the Endangered Species Act. *Id.* § 230.10(b)(3). Third, the Corps cannot issue the permit unless there is a demonstration that any discharge from

¹ 33 U.S.C. § 1344(a), (b), (d); *id.* § 1362(7) (defining “navigable waters” as “waters of the United States”); 33 C.F.R. § 328.3(a)(1), (5), (6) (defining “waters of the United States” to include waters that may be used in interstate commerce, tributaries of such waters, and wetlands adjacent to those tributaries and waters).

the project “will not have an unacceptable adverse impact either individually or in combination with known and/or probable impacts of other activities affecting the ecosystems of concern,” or if any discharge will result in significant adverse effects to water quality. *Id.* § 230.10(c). Fourth, the Corps cannot allow discharges unless “appropriate and practicable steps have been taken which will minimize potential adverse impacts of the discharge on the aquatic ecosystem.” *Id.* § 230.10(d). Finally, the Corps must determine that the project is in the “public interest” by weighing all “relevant” considerations and balancing all probable impacts of the proposed action against its alleged benefits. 33 C.F.R. § 320.4(a). Moreover, the Corps must independently verify all the information in the application. 40 C.F.R. § 1506.5(a). Taken together, these guidelines require “that the unnecessary alteration or destruction of wetlands should be discouraged as contrary to the public interest.” 33 CFR § 320.4(b)(1).

For the reasons discussed below, the analysis contained in the information provided by the Corps from Dominion Energy’s permit application fail to demonstrate that the proposed filling would comply with the Section 404(b)(1) guidelines, or that the Project is in the public interest.

A. The Corps Must Choose the Least Damaging Practicable Alternative

The Corp’s must consider alternative pipeline routes and choose the least damaging practicable alternative. 40 C.F.R. § 230.10(a). The proposed 14.5-mile pipeline route through Florence County runs adjacent to sensitive ecological areas including the Pee Dee. The route also will impact twenty-seven (27) jurisdictional wetlands and two (2x) tributaries.

In light of the possible risks and hazards associated with construction and operation of a gas pipeline, including the known risks of pollution, explosions and fires, the Corps must evaluate a range of alternative routes including routes that do not run adjacent to sensitive ecological areas such as wetlands and other aquatic ecosystems, parks, and forest lands, and choose the route that will cause the least amount of damage to the environment. Indeed, a pipeline catastrophe in one of these sensitive aquatic areas would cause devastating, long-term impacts as evidenced by the numerous incidents Dominion Energy has already been involved in that are described in more detail below.

The process for undertaking this analysis is clearly set out in the Corps’ guidelines implementing the CWA. First, the Corps must define the project’s “overall project purpose.” *Id.* § 230.10(a)(2). Second, the Corps must determine whether a project is “water dependent.” *Id.* § 230.10(a)(3). If the project is not water dependent, the Corps is required to presume alternatives that do not destroy aquatic resources are available under CWA regulations “unless clearly demonstrated otherwise.” 40 C.F.R. § 230.10(a)(3); *see also id.* §§ 230.3(m), 230.41. If the presumption applies, “the applicant must then rebut the presumption by ‘clearly demonstrate[ing]’ that a practicable alternative is not available.” *Id.* In addition, when a discharge involves a “special aquatic site,” the Corps must presume that all practicable alternatives that do not involve a discharge into that site would have less adverse impact on the aquatic ecosystem, unless the applicant can clearly demonstrate otherwise. 40 C.F.R. § 230.10(a)(3). “Special aquatic sites” include sanctuaries and refuges, wetlands, mudflats, vegetated shallows, coral reefs, and riffle and pool complexes. *Id.* §§ 230.40–230.45. With a project that is 14.5 miles long, certainly there are feasible alternatives at the applicant’s disposal that would avoid or further

reduce the extent of the proposed wetland impacts. The “Public Notice” does not indicate that any analysis of routes that avoid aquatic ecosystems was completed. Thus, the Corps must evaluate that and other alternatives.

Dominion Energy must not only demonstrate that its project is preferable to alternative routes, but that its proposed method of construction at each wetland crossing is the least environmentally damaging. 40 C.F.R. § 230.10(a). In particular, the methods the company has chosen at each of its twenty-seven (27) jurisdictional wetlands and two (2x) tributary crossings will make a significant difference as to the extent of the impacts to waterways if the Project is approved. The information provided by Dominion Energy falls far short of demonstrating that it will be employing the most environmentally protective construction methods. For example, 33 CFR § 337.1(a) states that the public notice should “include sufficient information to provide a clear understanding of the nature of the activity,” and “the types of equipment and methods of dredging and conveyance proposed to be used;” yet, the notice fails to identify the equipment or construction method that Dominion Energy will use to cross the wetlands and tributaries (*i.e.*, open cut trenches, HDD, etc.). 33 CFR § 337.1(a)(2). This is critical in light of Dominion’s track record of construction pollution in South Carolina. *See* Section G, *infra* (discussing how Dominion has already been cited in South Carolina for construction sediment contaminating upstate drinking water).

The Public Notice does not describe any practical alternatives and the extent of possible damages for each of those alternatives. Indeed the information available to the public to date does not indicate the project will meet the Corps’ legal obligations to ensure the least damaging practicable alternative that avoids the destruction of wetlands. Moreover, there is no indication that the Corps considered non-pipeline alternatives and alternatives that do not involve discharge of dredged or fill material into waters of the United States. Such alternatives could include generation of equivalent quantities of cleaner non-fossil fuel-based fuels. The Corps must fulfill its duty to evaluate and choose the least damaging alternative to ensure that the adverse impacts of the pipeline’s construction and operation are avoided. The Corps also must verify information supplied by Dominion Energy in its evaluation of the proposed project impacts.

B. The proposed pipeline must avoid destruction of wetlands to the extent practicable.

Corps regulations require that the Corps, in evaluating a proposed project and issuing section 404 dredge and fill permits, avoid destruction of wetlands to the extent practicable. 33 C.F.R. § 320.4(r). As further guidance, the Corps’ 404(b)(1) guidelines that “[t]he discharge of dredged or fill material in wetlands is *likely* to damage or destroy habitat and adversely affect the biological productivity of wetlands ecosystems by smothering, by dewatering, by permanently flooding, or by altering substrate elevation or periodicity of water movement.” 40 C.F.R. § 230.41(b) (emphasis added). The guidelines also state that a 404 permit should only be issued if the applicant takes “all appropriate and practicable steps to avoid and minimize adverse impacts to waters of the United States.” 40 C.F.R. § 230.91(c)(2). Accordingly, the Corps must ensure that Dominion Energy avoids destruction of wetlands and tributaries and avoid any other adverse impacts to these sensitive aquatic ecosystems.

According to the applicant, the proposed Pipeline would pass through twenty-seven (27) jurisdictional wetlands and two (2x) tributaries and cause both temporary and permanent

impacts to these sensitive and critical ecosystems. The Corps must verify this information and evaluate the scope of impacts, both size and extent to determine whether there are permanent impacts along the proposed pipeline's route that have not yet been disclosed, whether conversion of forested and scrub shrub wetlands to emergent wetlands will result in a loss of wetland function and/or a change of use of the waterbody, which indeed constitute significant adverse impacts.

The project also proposes to convert forested wetlands to emergent wetlands. Although the Corps does not consider conversion of wetland type a permanent loss of waters of the United States even if that conversion results in the permanent loss of certain functions, this position does not allow the Corps to avoid evaluating the adverse impacts of wetland conversion, and resulting loss of wetland function. It is the commenters' position that any deforestation of wetlands or other conversion of wetlands is a loss of waters, and the Corps' policy effectively permits projects that will permanently deforest unlimited acreage of high-quality forested wetlands. Indeed, such impacts, including loss of certain wetland functions, must not go unanalyzed.

Further, as set forth above, because the proposed project is not "water dependent," the Corps must evaluate alternatives that do not impact these sensitive aquatic ecosystems and that seek to avoid wetland destruction all together. The Corps also must evaluate the cumulative impacts to wetlands along the full pipeline route, including the cumulative impacts of the permanent removal of wetlands along the pipeline route and right of way, and the conversion of high-quality forested wetlands and scrub shrub wetlands to emergent wetlands. The Corps must identify the cumulative loss of wetland function resulting from the proposed project at a site specific, watershed and regional scale.

C. The proposed project must not cause or contribute to degradation of the environment or water quality

The Corps must not permit the proposed project if it causes or contributes to degradation of the environment. 40 C.F.R. § 230.10. In addition to aquatic and wetland resources, the Corps must evaluate the project's impacts, during construction and operation, to other environmental values, including wildlife and air quality, among others. This analysis must include evaluation of whether the proposed project jeopardizes the continued existence of species listed as endangered or threatened under the Endangered Species Act. 40 C.F.R. § 230.10(b)(3), and the impacts of pollution which are a known risk associated with the construction and operation of gas pipelines. Here, the project admits that it will endanger the federally listed Red-cockaded woodpecker but fails to emphasize the devastation of such impacts; deforestation removes the trees these birds rely on and it would take decades for any new growth tree to mature to the level at which they become habitable for the woodpeckers. The project also admits that it could impact another federally-listed endangered species, Canby's Cowbane, but fails to mention that this herb is threatened due to exactly what is proposed here: the degradation and loss of the wetland habitat in which it grows.² In the case of both Canby's Cowbane and the red-cockaded woodpeckers, much is unknown about their habits and needs, but what is clear is that the threats that led to their species becoming federally-listed persist today. This project should not be allowed to proceed until a complete assessment of the proposed impacts to these federally listed

² https://explorer.natureserve.org/Taxon/ELEMENT_GLOBAL.2.139094/Oxypolis_canbyi

species is completed and the project should be denied unless we can ensure their complete safety.

Moreover, the Corp's own guidelines state that "[n]o discharge of dredged or fill material shall be permitted if it: (1) Causes or contributes ... to violations of any applicable State water quality standard." 40 C.F.R. § 230.10(b)(1). The proposed project will affect will pass through twenty-seven (27) jurisdictional wetlands and two (2x) tributaries. Construction and operation of the project will increase pollutant loads to these waterbodies. Accordingly, the Corps must evaluate whether discharges from the proposed project will violate state water quality standards and lead to degradation of these waterbodies. As described in detail below, Dominion Energy's South Tyger River pollution caused long-term adverse impacts on the entire river system and has been very costly and difficult to clean up.

D. The Corps must take all appropriate steps to minimize potential adverse impacts of the proposed project

In addition to determining whether there are fewer damaging alternatives routes or activities to the proposed pipeline project, the Corps also must take all appropriate steps to minimize the project's adverse impacts. 40 C.F.R. § 230.10. Based on the public notice, Dominion Energy intends to purchase 12.7 mitigation credits from a third-party mitigation bank; however, Dominion Energy must provide explanation of mitigation or avoidance of temporary and permanent impacts on the project's full acreage. In relevant part, 40 CFR § 230.94(b)(1) states, "For an activity that requires a standard DA permit pursuant to section 404 of the Clean Water Act, the public notice for the proposed activity must contain a statement explaining how impacts associated with the proposed activity are to be avoided, minimized, and compensated for. This explanation shall address, to the extent that such information is provided in the mitigation statement required by 33 CFR 325.1(d)(7), the proposed avoidance and minimization and the amount, type, and location of any proposed compensatory mitigation, including any out-of-kind compensation, or indicate an intention to use an approved mitigation bank or in-lieu fee program." The Public Notice does not provide this detail. The Corps must first evaluate the comprehensive environmental impacts of the proposed project and require avoidance and mitigation measures for all potential impacts and allow for public participation on the impacts and proposed avoidance and mitigation plans.

E. The Corps must independently verify all information provided by Dominion Energy

The Clean Water Act requires that the Corps independently evaluate and verify the information supplied by the applicant in determining whether to issue a section 404 permit. 40 C.F.R. § 1506.5(b). As such, the Corps must not take Dominion Energy's analysis of impacts and possible alternatives at face value. The Corps must independently determine the scope and extent of impacts to aquatic ecosystems and the environment and determine whether there are any other less damaging alternatives to the proposed pipeline. Similarly here, the Corps should commission an independent engineering analysis to verify Dominion Energy's information about the risks of disaster and its ability to respond to a worst-case discharge of construction sediment into waterways. It must also demonstrate to the public that it has completed this independent analysis to ensure meaningful public participation. 33 U.S.C. § 1344(a).

F. The project risks dangerous hazards that demonstrate the project is not in the public interest.

The Corps must deny the Section 404 permit because the Dominion Energy Project is not in the public interest. Pursuant to the Corps' regulations implementing the Clean Water Act, the "decision whether to issue a permit will be based upon an evaluation of the probable impacts, including cumulative impacts, of the proposed activity and its intended use on the public interest." 33 C.F.R. § 320.4(a)(1). The public interest review is intentionally broad and should include all relevant issues that could impact the environment, human health, and natural resources.

The Corps' regulation instructs: Evaluation of the probable impact which the proposed activity may have on the public interest requires a careful weighing of all those factors which become relevant in each particular case. The benefits which reasonably may be expected to accrue from the proposal must be balanced against its reasonably foreseeable detriments. The decision whether to authorize a proposal, and if so, the conditions under which it will be allowed to occur, are therefore determined by the outcome of this general balancing process. That decision should reflect the national concern for both protection and utilization of important resources. 33 C.F.R. § 320.4(a)(1).

The Corps' regulations include a non-exhaustive list of factors that may be relevant for each individual project. 33 C.F.R. § 320.4(a)(1) states in part: All factors which may be relevant to the proposal must be considered including the cumulative effects thereof: among those are conservation, economics, aesthetics, general environmental concerns, wetlands, historic properties, fish and wildlife values, flood hazards, floodplain values, land use, navigation, shore erosion and accretion, recreation, water supply and conservation, water quality, energy needs, safety, food and fiber production, mineral needs, considerations of property ownership and, in general, the needs and welfare of the people. Consistent with the mandate that the Corps consider "all those factors that become relevant," this non-exhaustive list of factors includes issues beyond those related to the impacts of in-water work. *Id.* In other words, by requiring an analysis of "cumulative impacts" and by including a non-exhaustive, far-reaching list of factors, the Corps is clearly required to conduct a broad analysis of the public interest that captures all relevant impacts associated with the project and not just those that result directly from the permitted activities.

Here, in addition to admittedly affecting historic properties and habitats of Red cockaded woodpeckers and Canby's cowbane, Dominion Energy's safety record demonstrates that this project could pose serious risks to the environment and citizens. On November 15, 2019 at approximately 1:00 a.m., one of Dominion Energy's newly installed gas lines exploded at Pepper Pike³ in Ohio. An investigation by the Public Utilities Commission of Ohio (PUCO) resulted in a report issued February 28, 2020, revealing that the cause of the explosion and resulting fire was Dominion Energy's "failure to follow established welding procedures, insufficient inspection and oversight at the construction site, and lack of procedures and training regarding auger boring, which led to the pipeline being subject to excessive strain." *Id.* In detail, the report states:

³ <http://dis.puc.state.oh.us/CaseRecord.aspx?CaseNo=19-2140&x=0&y=0>

Staff believes Dominion showed a **lack of institutional control at the construction project** located at Shaker Blvd. in Pepper Pike. **Poor construction practices, failure to follow established procedures, and a lack of oversight all contributed** to the weld failure and pipeline rupture. Staff further believes that the number of bad welds found at the site, **Dominion's previous enforcement history related to not following or enforcing procedures in the field, and poor documentation practices** show that failures similar to the pipeline rupture in Pepper Pike **may recur in the future** if the factors that contributed to the rupture are not addressed. . . . Finally, given the severity of the violations, Staff recommends that a forfeiture of \$2,500,000 be assessed pursuant to O.R.C. 4905.95(B)(1)(b) against Dominion Energy Ohio for failure to comply with Pipeline Safety Regulations requirements that caused or contributed to this incident. **This incident posed a serious danger to the public. Given the destruction that it caused and the location, if this had happened during a period of high traffic, instead of at 1:00am, the likelihood that someone would have been injured or killed would have been significantly higher.**

Id. In March of this year, Dominion Energy was forced to pay \$1.4 million in fines after violating numerous state and federal environmental laws after secretly and illegally dumping more than 27 million gallons of polluted coal ash water into Quantico Creek in Virginia.⁴ Confronted with the discharge, Dominion Energy attempted to insisted the discharge was made in compliance with its Clean Water Act permit; however, an investigation showed that was not the case.

Dominion's violations are not just national, however. In 2018, Dominion was cited for failing to control sediment near a 55-mile pipeline it had built in the upstate of South Carolina.⁵ Sediment washing off the pipeline's construction sites wound up in creeks that feed into the South Tyger River, where the Woodruff-Roebuck Public Water District has an intake pipe. The runoff from Dominion's construction also worked its way into the river and clogged the pipe, causing the Woodruff-Roebuck system to buy water from another utility for more than 10,000 customers south of Spartanburg.⁶ Ultimately, a \$4,200 fine was issued by DHEC which Dominion Energy later stated had "minimal impact."⁷ Here, City of Florence drinking water is produced a surface water treatment facility that withdraws water from the Great Pee Dee River, which runs along the proposed pipeline.

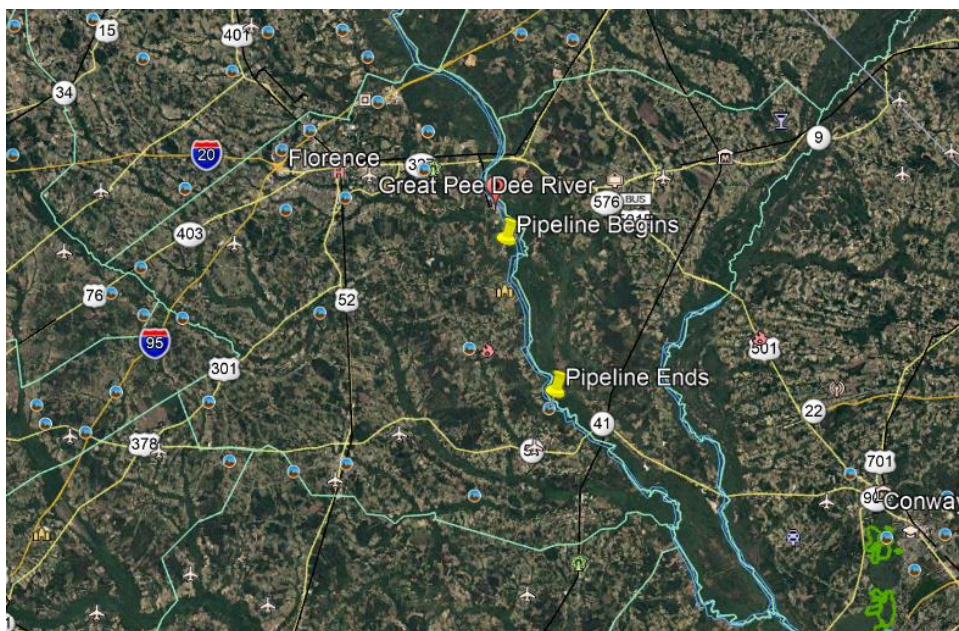
⁴ <https://www.oag.state.va.us/media-center/news-releases/1657-march-13-2020-dominion-to-pay-1-4-million-for-alleged-violations-of-virginia-s-environmental-laws-and-regulations>; *see also*

<https://files.constantcontact.com/bfcd0cef001/228a429a-f207-495f-b608-519ff30fa7d9.pdf>

⁵ <https://abcnews4.com/news/local/south-carolina-fines-dominion-energy-for-polluting-drinking-water>

⁶ <https://www.greenvilleonline.com/story/news/2018/05/25/dominion-energy-under-scrutiny-after-mud-clogs-water-system-near-utility-s-c-project/645320002/>

⁷ <https://www.dominionenergy.com/library/domcom/media/community/environment/reports-performance/water-cdp-2018.pdf?la=en&modified=20191021165021>



Considering Dominion Energy’s construction practices and procedures and its history of damaging South Carolina’s water supply, the applicant must prove more assurance to the public than a bare assurance that “Stormwater best management practices will be implemented during construction activities to minimize sedimentation.” The public needs specific information about the risks posed to its historic sites, Red cockaded woodpeckers and Canby’s cowbane. The Corps must deny this permit until the public receives the appropriate assurances that Florence’s water supply will not suffer the damage Dominion Energy caused in the upstate and that Dominion will not be able to leave the environment and its precious habitats scarred.

G. Dominion Energy’s Compensatory Mitigation is Inadequate.

As described more fully below, Dominion Energy and the Corps have provided minimal information about their plan to provide for mitigation or compensation of any of these wetland losses. The Corps must also include monitoring as part of its compensation and mitigation plans to determine the rate of restoration and additional measures if mitigation or compensation should fail. 40 CFR § 230.94(b)(1) states:

For an activity that requires a standard DA permit pursuant to section 404 of the Clean Water Act, the public notice for the proposed activity must contain a statement explaining how impacts associated with the proposed activity are to be avoided, minimized, and compensated for. This explanation shall address, to the extent that such information is provided in the mitigation statement required by 33 CFR 325.1(d)(7), the proposed avoidance and minimization and the amount, type, and location of any proposed compensatory mitigation, including any out-of-kind compensation, or indicate an intention to use an approved mitigation bank or in-lieu fee program. The level of detail provided in the public notice must be commensurate with the scope and scale of the impacts. The notice shall not include information that the district engineer and the permittee believe should be kept confidential for business purposes, such as the exact

location of a proposed mitigation site that has not yet been secured. The permittee must clearly identify any information being claimed as confidential in the mitigation statement when submitted. In such cases, the notice must still provide enough information to enable the public to provide meaningful comment on the proposed mitigation.

Id. (emphasis added).

Here, enough information is not provided to enable the public to provide meaningful comment on the proposed mitigation. The plan does not mention location and does not say whether this plan includes adequate compensation for the conversion of 1.5 acres of forested to emergent wetlands, yet simply states, “The applicant has proposed to mitigate for impacts to wetlands and/or waters of the United States by purchasing 12.7 mitigation credits from a third party mitigation bank.”

According to the Section 404(b)(1) guidelines, “[t]he fundamental objective of compensatory mitigation is to offset environmental losses resulting from unavoidable impacts to waters of the United States authorized by...permits.” 40 C.F.R. § 230.92(a)(1). Thus, the Corps “*must* determine the compensatory mitigation to be required in a...permit, based on what is practicable and capable of compensating for the aquatic resource functions that will be lost as a result of the permitted activity.” *Id.* (emphasis added). Compensatory mitigation may include restoration, enhancement, establishment, and preservation of aquatic ecosystems. *Id.* § 230.93(a)(2). In general, it should take place within the same watershed where unavoidable impacts occur. *See Id.* § 230.93(c)(1).

Indeed, the Corps cannot issue this permit with such significant information lacking from the application and without any opportunity for the public to comment on it. As such, the Corps and applicant must fully develop the plan and provide an opportunity for public to comment prior to issuing a 404 permit.

H. The cumulative impacts of this project have not been analyzed

The Corps must also evaluate the probable impacts, including cumulative impacts, of the project on the public interest and weigh any perceived benefits against reasonably foreseeable detriments. See 33 CFR § 320.4(a). Because wetlands constitute a productive and valuable public resource, their unnecessary alteration or destruction “should be discouraged as contrary to the public interest.” 33 CFR § 320.4(b). Similarly, DHEC’s 401 Water Quality Certification program requires that the agency consider all potential water quality impacts of the project, both direct and indirect, over the life of the project including:

- (a) Whether the activity is water dependent and the intended purpose of the activity;
- (b) Whether there are feasible alternatives to the activity;
- (c) All potential water quality impacts of the project, both direct and indirect, over the life of the project including:
 - (1) Impact on existing and classified water uses;
 - (2) Physical, chemical, and biological impacts, including cumulative impacts;
 - (3) the effect on circulation patterns and water movement;
- (4) The cumulative impacts of the proposed activity and reasonably foreseeable similar

activities of the applicant and others. S.C. Code Regs. R. 61-101(F)(3)(c).

Further, the regulations explicitly state that certification will be denied if: (a) the proposed activity permanently alters the aquatic ecosystem in the vicinity of the project such that its functions and values are eliminated or impaired; or (b) there is a feasible alternative to the activity, which reduces adverse consequences on water quality. S.C. Code Regs. 61-101.F.5. The EPA and Corps have acknowledged “peer-reviewed science and practical experience demonstrate that upstream waters, including headwaters and wetlands, significantly affect the chemical, physical, and biological integrity of downstream waters by playing a crucial role in controlling sediment, filtering pollutants, reducing flooding, providing habitat for fish and other aquatic wildlife, and many other vital chemical, physical, and biological processes.” 80 Fed. Reg. at 37,055.

In applying the above criteria, the Corps must make detailed factual determinations as to the potential environmental effects of the proposed discharges. *See Id.* §§ 230.11, 230.12(b). Crucially, these factual determinations depend on not only a project’s direct effects on aquatic ecosystems, but also the cumulative effects of other discharges and secondary effects associated with the project. *See Id.* § 230.11(g), (h). Thus, while the Section 404(b)(1) guidelines apply only to the waters of the United States and coextensive aquatic ecosystems, *see Id.* § 230.3(b), the Corps must consider the environmental impacts from additional predictable developments, as well as those indirectly caused by a project. In making these factual determinations, the Corps must evaluate the duration and physical extent of any impacts as well as the possible loss of environmental values for different waters. *E.g., Id.* § 230.11.

Here, the amount of fill and excavation proposed may appear slight in terms of total acreage, but the overall impacts that will follow from the loss of critical headwater stream habitat are significant. Moreover, this project will cross habitat that supports a number of valuable wildlife species and will cause impacts to that wildlife. The notice admits that the Red cockaded woodpeckers (*Picoides borealis*) and Canby's cowbane (*Tiedemannia canbyi*) may be affected but does not include any specific information about the actual loss of habitat over this 14.5-mile stretch. Many of the species that utilize streams for habitat are unable to easily relocate and would be subjected to increased threat without access to these waters. Headwater streams serve a particularly critical role in the health and vitality of an ecosystem, including providing nutrient production and exchange; refuge habitat from predators; spawning and rearing habitat; and migratory corridors.⁸

⁸ *See generally* Myer, Judy L., *et al.*, “The Contribution of Headwater Streams to Biodiversity in River Networks,” *Journal of the American Water Resources Association*, Vol. 43, No. 1 (Feb. 2007) (“[Headwater streams] offer an enormous array of habitats for microbial, plant, and animal life, but their small size also makes them especially sensitive to disruption. The streams are integral to the maintenance of biological diversity in the river network...[T]he strong biological linkages between these upstream habitats and downstream ecosystems enhance and maintain species diversity downstream. The diversity of life in headwater streams (intermittent, first and second order) contributes to the biodiversity of a river system and its riparian network. [These] small streams differ widely in physical, chemical, and biotic attributes, thus providing habitats for a range of unique species. Headwater species include permanent residents as well as migrants that travel to headwaters at particular seasons or life stages. Movement by migrants links headwaters with downstream and terrestrial ecosystems, as do exports such as emerging and drifting insects...Degradation of headwater habitats and loss of their connections to larger streams have negative consequences not only for inhabitants of small streams but also for the diversity of downstream and riparian ecosystems. In many respects and locales, the biological integrity of entire river networks may be greatly dependent on the individual and cumulative impacts occurring in the many small streams that constitute their

IV. CONCLUSION

The applicant has not met its burden on demonstrating why this proposal meets both the Corps' and DHEC's guidelines to warrant approval. For the foregoing reasons, the Corps should deny Dominion Energy's Section 404 permit application. Should the Corps decide to approve the permits, it must first provide substantial additional analyses, including detailed factual determinations about the full extent of direct, indirect, cumulative, and secondary impacts from the Dominion Energy Project. Because critical pieces of this analysis are missing from the Public Notice, as described above, the Corps should allow additional public comment on that supplementary material once it is provided to the public, as required under its regulations. Correspondingly, we urge the Corps of Engineers and DHEC to extend the public comment period, schedule a hearing for public comment on the above-referenced permit when the public can attend and ultimately deny the above-referenced application or, at a minimum, require applicant modify its application to reduce or eliminate aquatic impacts to the fullest extent possible. We request notification of any action or decision related to this project, preferably via email to lauren@scelp.org.

Thank you for your consideration of these important issues.

Sincerely,



Lauren Megill Milton

EXHIBIT B



PUBLIC NOTICE

Public Notice No. SAC 2019-01427

June 8, 2021

The South Carolina Department of Health and Environmental Control has received an application for an individual State Water Quality Certification (WQC) of a Department of the Army Corps of Engineers Nationwide Permit (**NWP 12**) pursuant to Section 401 of the Clean Water Act (33 U.S.C. 1341). The project also affects State navigable waters and the WQC review will consider issues of R.19-450, *Permits for Construction in Navigable Waters*, in accordance with the procedures of R.61-101, *Water Quality Certification*.

APPLICANT: Dominion Energy

WATERBODIES: Waters of the U.S. on the project site, including wetlands, drain east through Jefferies Creek, Mills Branch, Bigham Branch, Briar Branch, Barfield Mill Creek, Bullock Branch, and unnamed tributaries to the Great Pee Dee River. The Great Pee Dee River and Jeffries Creek are State navigable waters subject to the permitting jurisdiction of R.19-450.

ACTIVITY: The project is a gas main installation known as the River Neck to Kingsburg 16-inch Gas Main. The project consists of the installation of a 16-inch gas main within an approximately 40-foot-wide existing easement and a 10-footwide expansion of the easement to the west. The gas main will be installed through a combination of horizontal directional drilling (HDD) and open trench excavations. The crossing under Jeffries Creek will be installed by HDD. The proposed project will result in temporary clearing impacts to 6.326 acres of wetlands and 53 linear feet of stream, temporary excavation impacts to 8.35 acres of wetlands and 119 linear feet of stream, permanent fill impacts to 0.0041 acres of wetlands and 22 linear feet (0.0045 acre) of stream, and permanent clearing impacts to 2.986 acres of wetlands and 21 linear feet of stream. Following the initial clearing and placement of the gas main, native material will be placed to match preexisting grade and allowed to revegetate naturally. A smaller portion of the cleared areas within the ROW will be maintained as cleared land for future maintenance. The applicant is not proposing mitigation because the project will result in less than 0.01 acre of permanent fill impact in wetlands and less than 0.005 acre of permanent fill impact in streams. Dominion Energy stated the basic purpose of the proposed project is to install a gas main to support the growth in the area by providing the additional capacity and flexibility to meet the current and anticipated customer demands for natural gas. They stated that the overall purpose is to provide natural gas utilities in Florence County, South Carolina for developments requiring natural gas as an energy supply. The U.S. Army Corps of Engineers is processing the application for authorization under Nationwide Permit 12, Utility Line Activities (SAC 2019-01427). See also application materials, including supporting documentation, figures, and a frac-out plan appended to the DHEC public notice on the DHEC Environmental Public Notice webpage here: <https://scdhec.gov/permits-regulations/public-notices>.

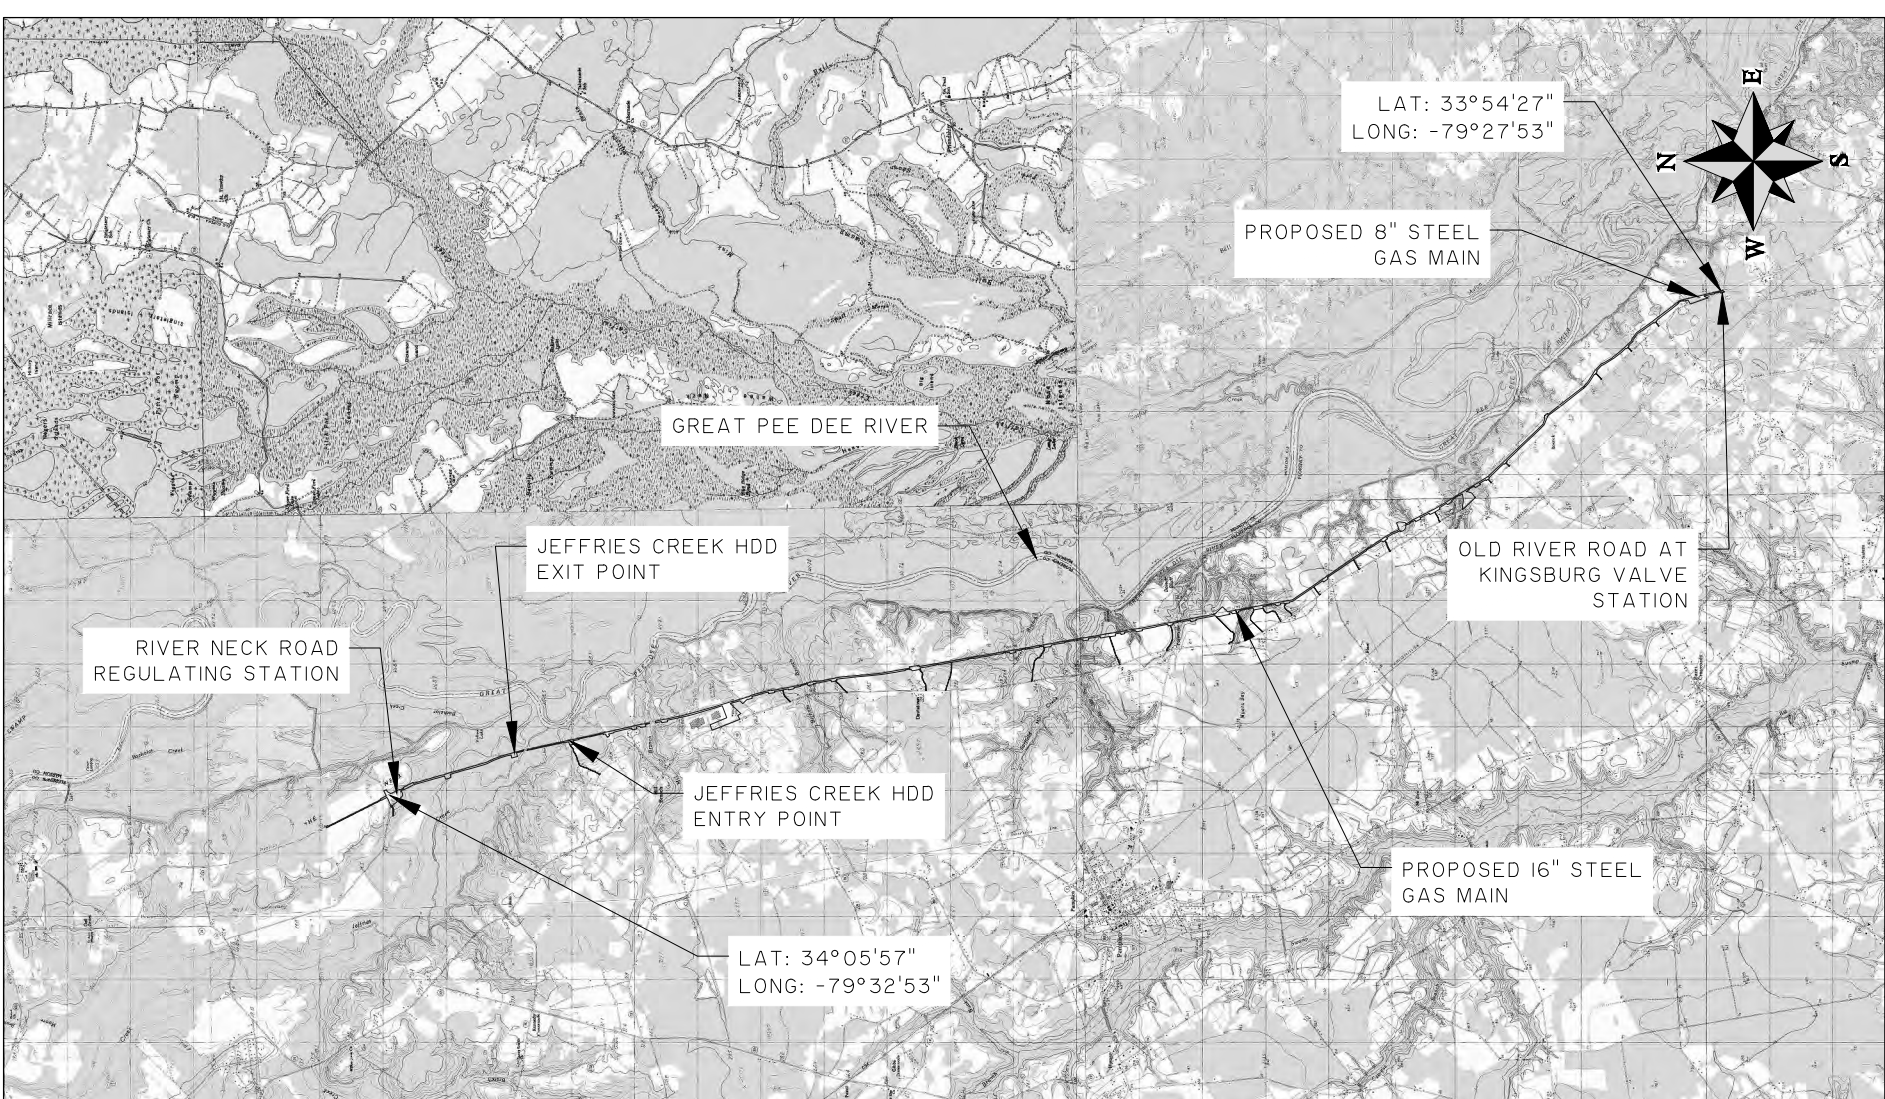
LOCATION: The proposed project corridor is located south of the Kingsburg Valve Station located near 2187 Old River Road in Johnsonville, Florence County South Carolina. The

proposed project corridor is an approximately 14.5 mile, 50-foot-wide corridor (40 feet of which is within an existing Dominion Energy right-of-way or ROW as described previously) located east of North Old River Road and South Old River Road starting near the intersection of River Neck Road and Wross Lane. The proposed pipeline will parallel an existing Dominion Energy 8-inch gas pipeline within an existing ROW. The proposed project corridor is located on the Pamlico North, Pamlico South, and Gres Ham United States Geological Survey (USGS) Topographic Map. The approximate center of the project corridor is located at 34.004307°N, -79.523488°W. See also attached map showing project corridor.

This public notice is being distributed to interested persons and agencies to gain comments, which will aid the South Carolina Department of Health and Environmental Control in making a final decision regarding the proposed work. All comments and data in support or opposition to the proposed work and related to compliance with water quality standards, protection of classified uses, and related water quality impacts should be submitted in writing to:

SC Department of Health and Environmental Control
Division of Water Quality
Attn: Rusty Wenerick
2600 Bull St
Columbia SC 29201-1708

Comments will be received at the above address until **June 23, 2021**.



RIVER NECK TO KINGSBURG 16" GAS MAIN

WETLAND IMPACT SITE MAP

CLIENT:
DOMINION ENERGY

LOCATION: FLORENCE COUNTY, SC	DRAWN BY: DNF	SHEET: 1
DATE: 5/27/2020	REVIEWED BY: JRS	SCALE: 1" = 1000'
JOB NUMBER: J-27886.0000		



682 Johnnie Dodds Blvd. • Suite 100
 Mt. Pleasant, SC 29464 • 843.849.0200
www.thomasandhutton.com

Section 404 Individual Permit Application Supporting Documentation

River Neck to Kingsburg 16" Gas Main Florence County, South Carolina

Terracon Project No. EN197161

June 2, 2021

Prepared for:

United States Army Corps of Engineers
1949 Industrial Park Road, Room 140
Conway, South Carolina 29526

South Carolina Department of Health and Environmental Control
Section 401 Water Quality Certification
2600 Bull Street
Columbia, SC 29201

Applicant:

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1450 Fifth Street West
North Charleston, SC 29405

In collaboration with:

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Mount Pleasant, South Carolina 29464

Section 404 Individual Permit Application

River Neck to Kingsburg 16" Gas Main ■ Florence County, South Carolina
 June 2, 2021 ■ Terracon Project No. EN197161



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- Exhibit 1 Site Location Map
- Exhibit 2 USGS Topographic Map
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- Exhibit 4 2006 Infrared Aerial Photograph
- Exhibit 5 USFWS NWI Map
- Exhibit 6 USDA-NRCS Soil Survey Map
- Exhibit 7 2018 Aerial View

Section 404 Individual Permit Application

River Neck to Kingsburg 16" Gas Main ■ Florence County, South Carolina
June 2, 2021 ■ Terracon Project No. EN197161



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- Appendix A Joint Federal and State Permit Application and Permit Drawings
- Appendix B Jurisdictional Determination Letter / Depiction of Aquatic Resources Map
- Appendix D Threatened and Endangered Species Survey /USFWS/SCDNR Coordination
- Appendix E Cultural Resources Survey Report and SHPO Coordination
- Appendix F Inadvertent Release Control Plan for HDD

Section 404 Individual Permit Application

River Neck to Kingsburg 16" Gas Main ■ Florence County, South Carolina

June 2, 2021 ■ Terracon Project No. EN197161

**EXECUTIVE SUMMARY**

Dominion Energy South Carolina is requesting a Section 404 Individual Permit to support the development of a gas main installation referred to as River Neck to Kingsburg 16" Gas Main. The proposed 212.2-acre project corridor (site) is located south of the Kingsburg Valve Station located near 2187 Old River Road in Johnsonville, Florence County South Carolina. The proposed site is an approximately 14.5 mile, 50-foot wide corridor with 40-feet within an existing Dominion Energy right-of-way (ROW) located east of North Old River Road and South Old River Road starting near the intersection of River Neck Road and Wross Lane. The proposed pipeline would parallel an existing Dominion Energy 8-inch gas pipeline within an existing ROW. The proposed site is located on the Pamlico North, Pamlico South, and Gres Ham United States Geological Survey (USGS) Topographic Map. The approximate center of the site is located at 34.004307°N, -79.523488°W. The project site contains 20.84 acres of jurisdictional aquatic resources.

There is an increasing demand for natural gas in eastern South Carolina due to residential, commercial and industrial growth. Dominion Energy has determined the basic purpose of the proposed project is to install a gas main to support the growth in the area by providing the additional capacity and flexibility to meet the current and anticipated customer demands for natural gas. The overall purpose of the proposed project is to provide natural gas utilities in Florence County, South Carolina for developments requiring natural gas as an energy supply.

The application complies with the conditions for Nationwide Permit (NWP) 12 - Utility Line Activities. NWP 12 was vacated on April 15, 2020 by the US District Court for the District of Montana based on a decision in the case of Northern Plains Resource Council v. U.S. Army Corps of Engineers. Due to NWP 12 being vacated this application includes a practicable alternatives analysis, which demonstrates compliance with CFR 40 Part 230 Section 404(b)(1) in order to obtain an Individual Permit. Based on the evaluation of the alternative sites, the only site determined to meet the objectives of the project purpose and need while minimizing impacts to aquatic resources to the maximum extent is utilization of an existing Dominion Energy ROW. The proposed project will result in 6.337 acres of temporary clearing impacts, 8.378 acres of temporary excavation impacts, 0.009 acres of permanent fill impacts, and 2.990 acres of permanent clearing impacts within jurisdictional freshwater wetlands and non-wetlands waters. The proposed wetland impacts associated with the project are depicted in the permit drawings in Appendix A.

The proposed impacts associated with the project do not conflict with Section 23(c) of the 2017 Nationwide Permit General Conditions or the Final Regional Conditions for 16 Nationwide Permits in Charleston District, dated March 15, 2021. No mitigation is proposed because the project will not result in more than 1/10-acre of discharge of dredged or fill material into WOTUS, including wetlands at the proposed impact locations. Additionally, the project will not result in more than 0.005-acre loss of intermittent and/or perennial stream bed for a single crossing. Clearing impacts are the only permanent impacts associated with the project over 1/10-acre.

Section 404 Individual Permit Application

River Neck to Kingsburg 16" Gas Main ■ Florence County, South Carolina

June 2, 2021 ■ Terracon Project No. EN197161

**1.0 INTRODUCTION**

The River Neck to Kingsburg 16" Gas Main project would result in unavoidable impacts to wetlands. This submittal includes a "Joint Federal and State Application Form for Activities Affecting Waters of the United States (WOTUS)". This application and supporting documentation:

- Provides documentation for United States Army Corps of Engineers (USACE) demonstrating compliance with CFR 40 Part 230 Section 404(b)(1) Clean Water Act (CWA);
- Presents applicable environmental documentation to support USACE in making a decision with regard to 42 USC § 4321 et seq. National Environmental Policy Act (NEPA);
- Demonstrates compliance with the requirements of 33 USC §§ 403, 407, 1341, and 1344 CWA;
- Demonstrates compliance with the regulatory requirements set forth in the USACE's regulations at 33 CFR Parts 320-332.

The proposed project is expected to commence upon the approval of the Individual Permit by USACE and SCDHEC.

1.1 Project Location

The proposed 212.2-acre project corridor (site) is located northeast of the Kingsburg Valve Station located near 2187 Old River Road in Johnsonville, Florence County South Carolina. The proposed site is an approximately 14.5 mile, 50-foot wide corridor with 40-feet within an existing Dominion Energy right-of-way (ROW) located east of North Old River Road and South Old River Road starting near the intersection of River Neck Road and Wross Lane. The proposed pipeline would parallel an existing Dominion Energy 8-inch gas pipeline within an existing ROW. The proposed site is located on the Pamplico North, Pamplico South, and Gres Ham United States Geological Survey (USGS) Topographic Map. The approximate center of the site is located at 34.004307°N, -79.523488°W.

1.1.1 Watershed

The site is located in the Middle Pee Dee River Watershed [Hydrological Unit Code (HUC) 03040201]. WOTUS, including wetlands on the site drain east through Jefferies Creek, Mills Branch, Bigham Branch, Briar Branch, Barfield Mill Creek, Bullock Branch, and Unnamed Tributaries to the Great Pee Dee River. Jefferies Creek and Great Pee Dee River are listed on the 2016 South Carolina List of Impaired Waters by 12-Digit HUC.

Section 404 Individual Permit Application

River Neck to Kingsburg 16" Gas Main ■ Florence County, South Carolina
 June 2, 2021 ■ Terracon Project No. EN197161



1.1 Description of Proposed Project

The project consists of the installation of a 16" gas main within an approximately 40 feet wide easement and including a 10 feet expansion of the easement to the west, all which is 212.2 acres. The gas main will be installed through a combination of horizontal directional drilling (HDD) and open trench excavations. The proposed project will result in 6.337 acres of temporary clearing impacts, 8.378 acres of temporary excavation impacts, 0.009 acres of permanent fill impacts, and 2.990 acres of permanent clearing impacts within jurisdictional freshwater wetlands and non-wetlands waters. Following the initial clearing and placement of the gas main native material will be placed to match preexisting grade and allowed to revegetate naturally. A smaller portion of the cleared areas within the ROW will be maintained as cleared land for future maintenance.

1.2 Site History

Readily available historic USGS topographic maps and selected historical aerial photographs were reviewed to obtain information concerning the history of the site. The site has historically consisted of cleared ROW, agricultural land, and wooded land.

1.3 Existing Site Conditions

Undeveloped portions of the site consist of cleared land and wooded land. The majority of the site consists of cleared and maintained ROW, agricultural land, and undeveloped wooded land. The wooded land on the site consists of a combination of mixed pine-hardwood forest and forested wetlands. Figure 1 is a 2018 aerial view of site depicting general existing conditions.

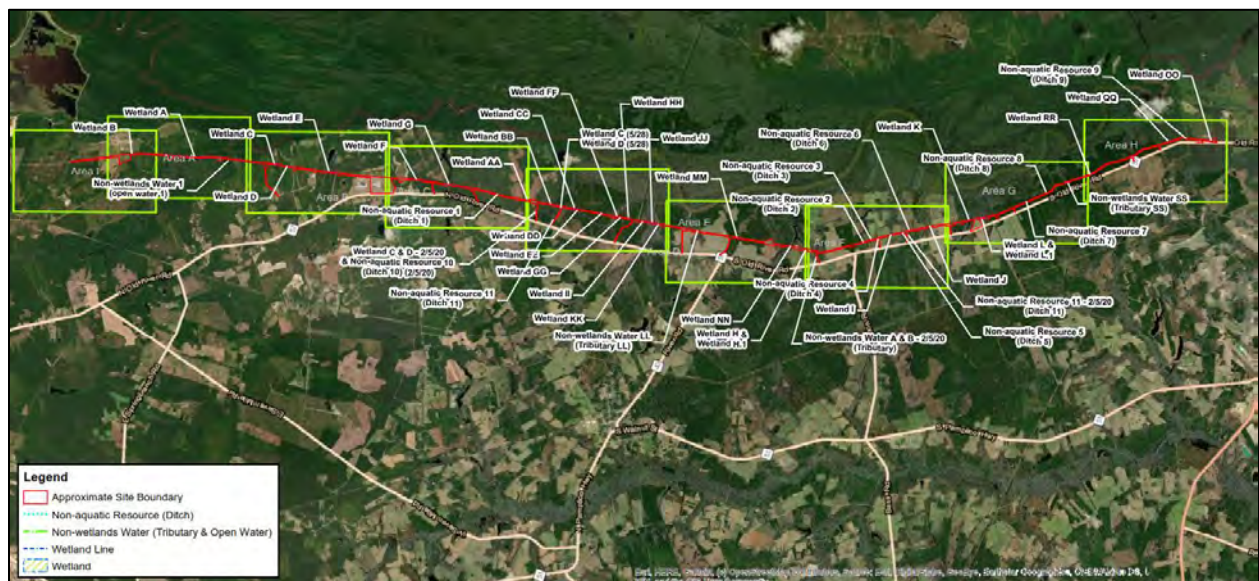


Figure 1: 2018 Aerial view of site depicting general existing conditions

Terracon delineated the wetlands within the project boundary on June 4, 2019 through June 6, 2019 and December 19, 2019. A Jurisdictional Determination (JD) Request package (SAC-2019-01427), dated August 21, 2019 was submitted to the U.S. Army Corps of Engineers (USACE). The USACE completed a JD letter, dated May 27, 2020, which is included in Appendix B.

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Terracon visited the site and delineated wetlands within portions of a revised boundary on May 28, 2020. The revised boundary and delineation is depicted in the Depiction of Aquatic Resources Map included in Appendix B. The WOTUS identified during the Jurisdictional Determination process are depicted in Figure 1.

The proposed wetland impacts are non-Section 10 freshwater wetlands. The overstory in the wetland areas primarily consists of loblolly pine (*Pinus taeda*), blackgum (*Nyssa sylvatica*), swamp tupelo (*Nyssa biflora*), bald cypress (*Taxodium distichum*), sweetgum (*Liquidambar styraciflua* L.), water oak (*Quercus nigra*), and red maple (*Acer rubrum*). The understory primarily consists of sweetgum (*Liquidambar styraciflua* L.), dogfennel (*Eupatorium capillifolium*), redbay (*Persea borbonia*), wax myrtle (*Morella cerifera*), smooth blackberry (*Rubus Canadensis*) and switchcane (*Arundinaria tecta*). The majority of the overstory is outside of the predominantly cleared ROW and outside of the proposed wetland impact areas.

The upland vegetation that is not cleared or planted agricultural land predominantly consists of loblolly pine (*Pinus taeda*), southern red oak (*Quercus falcata*), sweetgum (*Liquidambar styraciflua* L.), and water oak (*Quercus nigra*). Saplings and shrubs consist of sweetgum (*Liquidambar styraciflua* L.) and southern dewberry (*Rubus trivialis*).

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**2.0 PRACTICABLE ALTERNATIVES ANALYSIS**

As a component of the permit applications to discharge dredged or fill material into WOTUS, the USACE is required to analyze and evaluate alternatives to the proposed project that could achieve its purpose and need. The USACE conducts this analysis pursuant to two main requirements:

- The 404(b)(1) Guidelines (Guidelines) associated with the CWA of 1972, Federal Register, 40 CFR Part 230, and
- The USACE Implementation Procedures for the NEPA of 1969, Federal Register, 33 CFR Part 325, Appendix B.

The USACE must evaluate reasonable and practicable alternatives that accomplish the overall project purpose. As stated in the Guidelines, no discharge of dredged or fill material shall be permitted if there is a practicable alternative to the proposed discharge which would have less adverse impact on the aquatic ecosystem, so long as the alternative does not have other significant adverse environmental consequences. The Guidelines include two rebuttable presumptions.

The first presumption states that if a project does not need to be in a special aquatic site, such as a wetland, to meet its basic purpose, the project is not "water-dependent", and it is presumed that alternatives that do not affect special aquatic sites are available. The second presumption states that if a project involves a discharge of dredged or fill material into a special aquatic site, a practicable alternative located in uplands is presumed to have less adverse impact on the aquatic ecosystem.

The applicant must identify and analyze alternatives that would support a rebuttal of the aforementioned presumptions in order for the USACE to determine the project has passed the alternatives portion of the Guidelines. The alternatives analysis must include several key parameters, which are briefly described below and explored in greater detail in the document. Generally, the parameters are broken down into the following steps:

- **Define Purpose and Need:** The applicant's purpose and need should clearly state the overall project purpose and need without being so restrictive to exclude other alternatives. Correspondingly, the purpose and need should not be too general in nature so that it does not take the applicant's real needs into consideration.
- **Identification of Alternatives:** The applicant must identify the alternatives that would meet the overall project purpose.

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- **Evaluation of Alternatives for Practicability:** The applicant must demonstrate which alternatives that are practicable and/or non-practicable with respect to the overall project purpose.
- **Identification of the Least Environmentally Damaging Practical Alternative:** The Guidelines require that the Least Environmentally Damaging Practicable Alternative (LEDPA) be selected.

2.1 Project Purpose and Need

The identification of the purpose and need is the first step for USACE to evaluate the proposed project in accordance with the Guidelines. Similarly, the NEPA process also requires development of a purpose and need for the project. The project purpose forms the groundwork for the USACE to evaluate compliance with the Guidelines and NEPA.

Dominion Energy has determined the basic purpose of the proposed project is to install a gas main to support the growth in the area. The overall purpose of the proposed project is to provide natural gas utilities in Florence County, South Carolina for developments requiring natural gas as an energy supply.

2.1.1 Considerations in Development of Purpose and Need

Florence County has experienced significant business and job growth in recent years and last year (2019) the County secured \$89 million in industry investment and 403 arriving jobs. With Florence County Economic Development Partnerships, the momentum in growth is expected to continue and city leaders plan to increase partnerships with universities and technical colleges to provide training and the education of employers coming to the area. Announcements of new industry to locate in Florence County is expected. In addition to Florence County economics, job growth has occurred in Horry County which is spreading west toward Florence County. Based on these predictions, the energy supply demand will rapidly increase in the corridor between Florence and Horry County¹.

Dominion Energy's primary mission is to serve their customers safely and reliably; strengthen their communities; reward their shareholders; minimize environmental impacts and live their values. Due to the energy demand in the area Dominion Energy's goal is to fulfill and serve their customers while meeting all aspects of their primary mission.

¹ <http://www.fcedp.com/press2020/article466987c9508523.htm>

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**2.1.2 Rebuttal of Water Dependency**

The proposed project is not water dependent. According to the USACE, examples of water dependent projects may include, but are not limited to certain boat launching facilities, mooring facilities and docks².

2.2 Development of Alternatives

Based on the CWA 404(b)(1) Guidelines associated with the CWA of 1972, (40 CFR Part 230), there is a presumption that alternatives exist which do not affect special aquatic sites. Therefore, the applicant explored multiple alternatives, which included identifying alternative sites addressing this presumption, while meeting the project purpose.

In preparation for the proposed project, Dominion Energy developed a team of in-house representatives and external consultants to assist in the planning, permitting, and mitigation efforts associated with the project.

The alternatives for the proposed project were developed based on the purpose and need and in support of the rebuttal of the aforementioned presumptions. The proposed project would result in unavoidable impacts to wetlands during development. The planning included consideration of off-site and on-site alternatives. The goal during project master planning was to conceptually identify initial and future needs of a development and the effects to natural environment to the maximum extent practicable so permitting and mitigation can be identified and addressed appropriately in the early stages of a project.

The goal of the alternatives analysis development process is to evaluate a reasonable range of alternatives³ that meet the project purpose and project specific criteria, while resulting in the LEDPA. The range of alternatives considered may have varying degrees of impacts to environmental quality.

² *Guidelines For Preparation of Analysis of Section 404 Permit Applications Pursuant To The Section 404(B)(1) Guidelines Of The Clean Water Act (40 CFR, Section 230),*
http://www.sas.usace.army.mil/Portals/61/docs/regulatory/IP_SAS_404_b_1_Guidelines.pdf

³ *"range of alternatives" refers to the alternatives discussed in environmental documents. It includes all reasonable alternatives, which must be rigorously explored and objectively evaluated, as well as those other alternatives, which are eliminated from detailed study with a brief discussion of the reasons for eliminating them. Section 1502.14. A decision maker must not consider alternatives beyond the range of alternatives discussed in the relevant environmental documents.*

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The alternatives developed for this project include:

- alternative site locations, including those that might involve less adverse impacts to wetlands and/or WOTUS
- alternatives that would involve greater adverse impact to WOTUS
- alternatives that would result in no change to the project site

2.2.1 Site Selection Criteria

The alternatives evaluated are based on specific site selection criteria identified during development of the purpose and need of the proposed project. Dominion Energy developed the following site selection criteria as a measure of a successful gas main installation from River Neck Road Regulating Station to Kingsburg Valve Station, which are listed in order of priority and described below.

1. Location within an existing easement
2. Ability to acquire agreements for easements
3. Ability to avoid permanent clearing impacts
4. Distance from River Neck Road Regulating Station to Kingsburg Valve Station
5. Readily accessible

2.2.1.1 Location within an Existing Easement

Co-location of the proposed pipeline within an existing ROW is the primary site selection criteria identified by Dominion Energy. Conformance with this criterion would result in avoidance of new impacts to sensitive resources and other indirect environmental impacts associated with obtaining new easements.

2.2.1.2 Ability to Acquire Agreements for Easements

Alternative sites considered would be reasonably obtainable through easements. The applicant's site selection criteria includes the requirement for a site to be reasonably attainable through easement and must afford Dominion the ability to make limited use of another entity's real property. An attainable site was determined by the applicant to consist of land assumed to be available for easements. Constraints regarding owner agreements and easement terms were also a contributing factor for the applicant's section process.

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**2.2.1.3 Ability to Avoid Permanent Clearing Impacts**

The applicant intends to minimize the amount of impacts to the WOTUS through selection of a site that allows avoidance and minimization of impacts to jurisdictional waters to the maximum extent practicable while achieving the project purpose and need. The amount of fill impacts for any given linear utility ROW design is negligible due to the nature of the installation of underground utilities. Most fill impacts are ancillary, such as rip rap for culverts or other minor stabilization measures. The primary permanent impact associated with utility ROWs is permanent clearing. Therefore, the efforts to minimize permanent clearing impacts to WOTUS and uplands was the focus.

2.2.1.4 Distance from River Neck Road Regulating Station to Kingsburg Valve Station

The shortest distance between two points is a straight line. The proposed site must be located in an area that will limit the length and horizontal distance of the proposed pipeline to the maximum extent practicable. Limiting the horizontal distance and variations with the proposed pipeline will also minimize the need to use angles and bends, which require field fabrication and result in stress and strain on the pipeline and delays in construction.

2.2.1.5 Readily Accessible

The site must be readily accessible from existing roadways that minimizes the need for creating temporary access roads during construction. Readily accessible also relates to the ability to access to the ROW for future maintenance.

2.3 Alternatives Considered

The alternatives considered for the proposed project include no-action, offsite, and onsite alternatives in accordance with the Guidelines.

2.3.1 No-action Alternative

NEPA requires the alternatives analysis to include the "no-action" alternative (40 CFR 1502.14(d)). There are two individual interpretations of "no action" alternative that must be considered depending on the nature of the proposal being evaluated. In some cases "no action" is "no change" from current use or management of the site. Therefore, the "no action" alternative may be thought of in terms of continuing with the present course of action.

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The second interpretation of "no action" entails instances involving federal decisions on proposals for projects. "No action" in such cases would mean the proposed activity would not take place, and the resulting environmental effects from taking no action would be compared with the effects of permitting the proposed activity or an alternative activity to go forward. Where a choice of "no action" by the agency would result in predictable actions by others, this consequence of the "no action" alternative should be included in the analysis⁴.

Neither interpretation of the no-action alternative meets the purpose and need of the proposed project.

2.3.2 Alternative Sites

Three alternative site locations were identified and evaluated based on the project purpose and the site selection criteria identified in Section 2.2. The alternative site locations evaluated are depicted below. A comparison of each alternative site relative to the project purpose and site selection criteria is also included.

As part of the site selection process, Terracon conducted a review of readily available resources to assist with identifying potential WOTUS on alternative sites. These resources include USGS Topographic Maps, United States Fish and Wildlife Service (USFWS) National Wetlands Inventory (NWI) Map, United States Geological Survey (USGS) National Hydrography Dataset (NHD), USDA-NRCS Web Soil Survey data, topographic data, aerial photographs and other applicable information. Terracon in no way claims to have specialized knowledge of the aquatic features on the alternative sites evaluated. Each alternative site should be reviewed independently for potential aquatic resources and reviewed by applicable regulatory agencies to determine the presence and extent of aquatic resources as applicable and required by Section 404 of the Clean Water Act. Terracon's evaluation is based solely on desktop evaluation of readily available government resources unless specified otherwise.

Following review of each alternative sites using the site selection criteria, the alternative route with the fewest impacts to WOTUS was further evaluated for onsite alternatives analysis. While it is not reasonable to evaluate every potential alternative, the applicant has identified three alternatives sites that are generally representative of the various alternatives that could be implemented for this project. Figure 2 depicts the three alternative sites evaluated, which include the utilization an existing Dominion Energy ROW with an expanded footprint (Preferred Site), establishing a new easement along transportation ROWs, and establishing a new easement adjacent to the existing Dominion Energy ROW.

⁴ *Council On Environmental Quality, Executive Office of the President, Memorandum to Agencies: Forty Most Asked Questions Concerning CEQ's National Environmental Policy Act Regulations, 46 Fed. Reg. 18026 (March 23, 1981), As amended*

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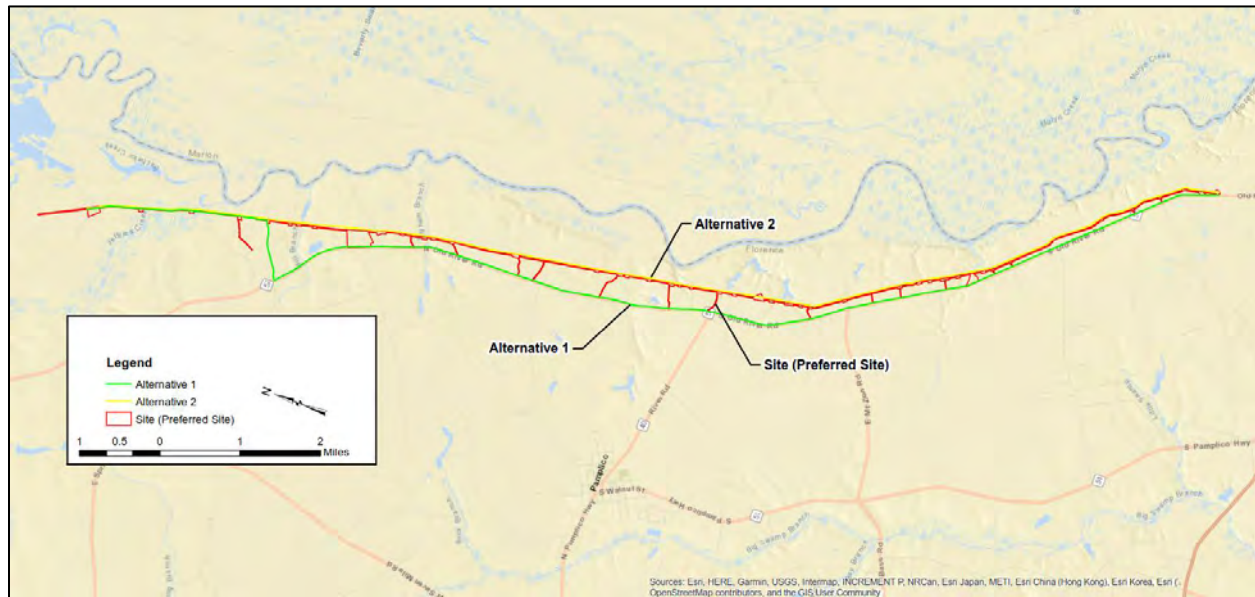


Figure 2: Alternative Sites

2.3.2.1 Existing ROW with Expanded Footprint (Preferred Site)

The approximately 212.2-acre site is 14.5 miles in length is located to the east of North Old River Road and South Old River Road starting near the intersection of River Neck Road and parallels the existing Dominion Energy 8-inch pipeline extending south of the Kingsburg Valve Station located near 2187 Old River Road in Johnsonville, Florence County South Carolina. The site boundary consists of an approximately 50-foot wide corridor with 40-feet within the existing Dominion Energy easement and an additional 10-foot expanded footprint to the west of the current easement. The existing easement predominantly consist of maintained cleared land.

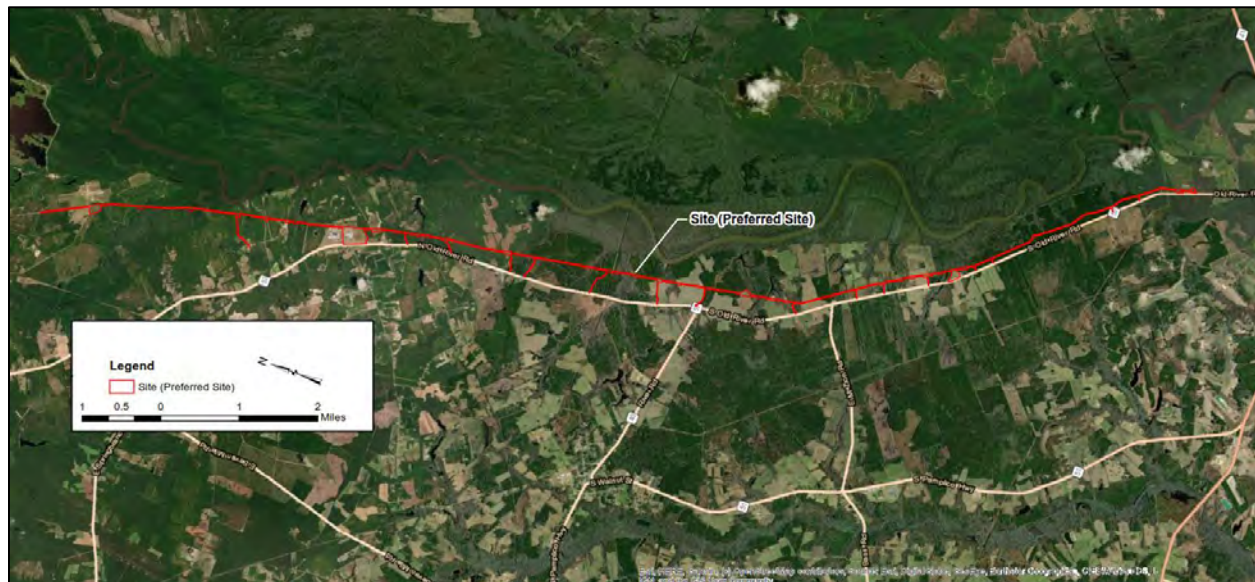


Figure 3: Existing ROW with Expanded Footprint (2018 Aerial View)

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**Exiting ROW with Expanded Footprint - Site Selection Screening Criteria:**

Location of existing easements: The majority of the preferred site is located with an existing Dominion Energy ROW located east of North Old River Road and South Old River Road starting at River Neck Road Regulating Station and ending at the Kingsburg Valve Station. The site predominantly contains cleared and actively maintained utility ROW.

Ability to acquire agreements for easements: The majority of the site is within the existing Dominion Energy's easement and acquisition of new easements is reduced to a minimal area.

Ability to avoid permanent clearing impacts: Due to the need to permanently clear the land within the expanded footprint west of the easement to maintain future access, locating the proposed site in an existing cleared utility ROW will result in the fewest impacts to WOTUS when compared to other alternatives requiring new easements. The total permanent clearing for this option is approximately 19.2 acres. The total permanent clearing impacts to WOTUS would be 2.99 acres using this option.

Distance from River Neck Road Regulating Station to Kingsburg Valve Station: Approximately 14.5 miles

Readily accessible: Site is readily accessible via multiple paved roads. Temporary access roads from North Old River Road and South Old River Road have been minimized to the maximum extent practicable.

2.3.2.2 Alternative 1- New Easement Along Transportation ROWs

Alternative 1 would extend 2.25 miles from the River Neck Road Regulating Station through the existing Dominion ROW. The alignment would be routed west along Pine Bluff Road for 0.3 miles and then south along North Old River Road and South Old River Road for approximately 12.3 miles and finally ending at the Kingsburg Valve Station.

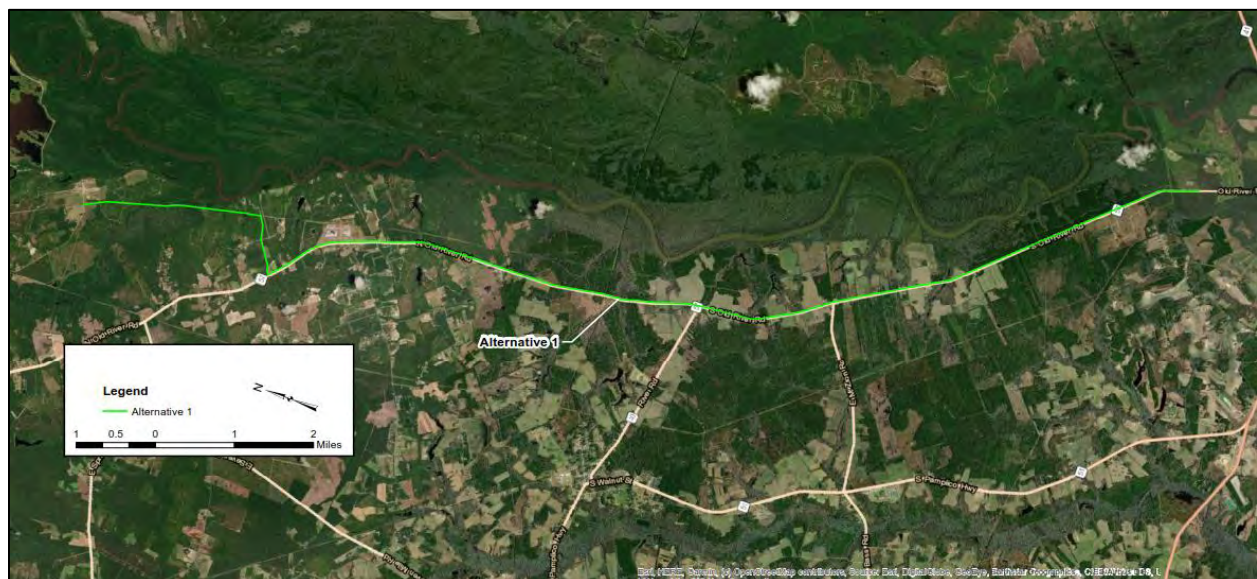


Figure 4: Alternative 1- New Easement Along Highway (2018 Aerial View)

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Alternative 1- New Easement Along Transportation ROWs- Site Selection Screening Criteria:

Location of existing easements: This alternative site is not located within a Dominion ROW and would require new easements to be negotiated along the transportation ROWs.

Ability to acquire agreements for easements: Based on review of the Florence County Parcel Search Map available on the Florence County SC Website, the North Old River Road and South Old River Road ROW is 70 feet in width. The road shoulders are 20 feet in width, therefore, an additional 30 feet of easement width would be required for this alternative, which translates to approximately 3.5 acres of wetland clearing impacts based on review of desktop resources. The ability to acquire easements along the transportation ROW is not known; however, based on past experience, property owners along the transportation ROW may not be amenable for easement negotiations, which could result in the need to bypass those properties by incorporating circuitous routes that may have greater impacts to aquatic resources.

Ability to avoid permanent clearing impacts: Due to the need to permanently clear the land within the additional easement to maintain future access, this alternative alignment would result in greater impacts to WOTUS, including wetlands compared to utilization of the preferred alternative. The total permanent clearing for this option is approximately 30 acres. The total permanent clearing impacts to WOTUS, including wetlands would be 3.5 acres using this option.

Distance from River Neck Road Regulating Station to Kingsburg Valve Station: Approximately 14.85 miles

Readily accessible: This alternative site would be readily accessible along North Old River Road and South Old River Road. The northern portion of this alignment, north of Pine Bluff Road, would be accessible through various improved roads.

2.3.2.3 Alternative 2 - Establishing a New Easement Adjacent to the Existing Dominion Energy ROW

Alternative 2 would result in establishing a new easement east of the existing Dominion Energy ROW along the current alignment to accommodate the proposed gas main.

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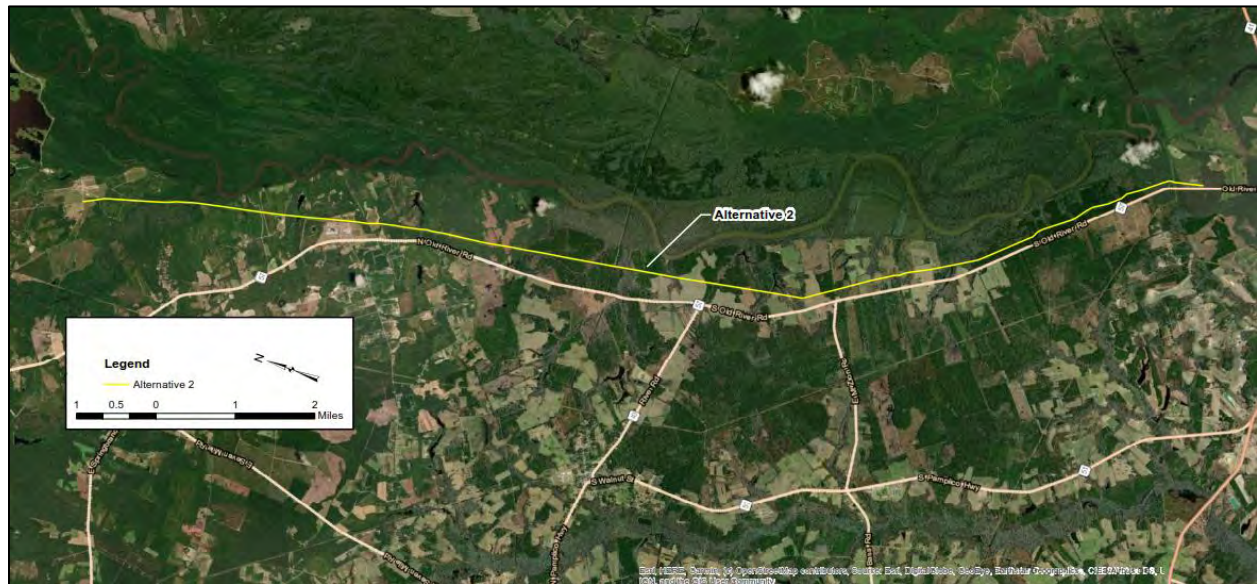


Figure 5: Alternative 2- Establishing a New Easement Adjacent to the Existing Dominion Energy ROW (2018 Aerial View)

Establishing a New Easement Adjacent to the Existing Dominion Energy ROW - Site Selection Screening Criteria:

Location of existing easements: This alternative alignment is not located within a Dominion ROW and would require new easements to be negotiated.

Ability to acquire agreements for easements: The ability to acquire 50-foot easements along the transportation ROW is not known; however, based on past experience, property owners may not be amenable for easement negotiations, which could result in the need to bypass those properties by incorporating circuitous routes that may have greater impacts to aquatic resources.

Ability to avoid permanent clearing impacts: Due to the need to permanently clear the land within the new easement to maintain future access, this alternative alignment would result in greater impacts to WOTUS, including wetlands than utilizing the preferred alternative. The total permanent clearing for this option is approximately 70 acres. The total permanent clearing impacts to WOTUS, including wetlands would be 14.6 acres using this option.

Distance from River Neck Road Regulating Station to Kingsburg Valve Station: Approximately 14.5 miles

Readily accessible: Site is readily accessible via multiple paved roads. Temporary access roads from North Old River Road and South Old River Road have been minimized to the maximum extent practicable and would match the temporary access roads depicted in the preferred route, which are depicted in Figure 3.

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**2.3.3 Summary of Alternative Sites - Site Selection Criteria**

Multiple alternative sites were identified and evaluated based on the project purpose. The alternative sites were analyzed based on the site selection criteria listed in order of priority. A summary of the alternative sites evaluated is included in Table 1.

Table 1: Summary of Alternative Site Evaluation Based on Site Selection Criteria

Project Criteria	Utilize Existing ROW with Expanded Footprint (Preferred Site)*	Alternative 1- New Easement Along Transportation ROWs*	Alternative 2- Establishing a New Easement Adjacent to the Existing Dominion Energy ROW*
Location within an existing easement	40-feet located within a cleared and actively maintained utility easement	Not within an existing utility easement	Not within an existing utility easement
Ability to acquire agreements for easements	Minimal amount of new easement area required	Unknown	Unknown
Ability to avoid permanent clearing impacts	Total permanent clearing impacts: 19.2 Total Permanent Clearing WOTUS Impacts = 2.99 acres	Total permanent clearing impacts: 30 acres Total Permanent Clearing WOTUS Impacts = 3.5 acres	Total permanent clearing impacts: 70 acres Total Permanent Clearing WOTUS Impacts = 14.6 acres
Distance from River Neck Road Regulating Station to Kingsburg Valve Station	14.5 miles	14.85 miles	14.5 miles
Readily Accessible	Yes	Yes	Yes

*Acreages are approximate

Based on the evaluation of the alternative routes, the alignment resulting in the least impacts to WOTUS would be utilization of the existing Dominion Energy utility ROW with expanded footprint. Additionally, the utilization of the existing Dominion Energy ROW would prevent the need for obtaining 50-feet of new easements and clearing of upland forests. Therefore, the utilization of the existing Dominion Energy ROW was further evaluated to identify the LEDPA.

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**2.3.4 Onsite Design Alternatives**

The use of the existing Dominion Energy ROW was chosen for further evaluation of alternative onsite designs based on the alternative resulting in the fewest environmental impacts and because minimal amount of new easement area would be required using this alternative. In an effort to identify reasonable practicable alternatives for the onsite design, multiple onsite installation methods were evaluated that coincide with the purpose and need. It is not practical to detail every variation of each onsite alternative evaluated; therefore, the various installation methods have been broken down into two alternatives that are representative of the variations. The amount of fill impacts required for the project is negligible; therefore, the main focus of the avoidance and minimization of aquatic resource impacts was reducing the permanent clearing needed to successfully complete the gas main installation.

2.3.4.1 Onsite Alternative A: Horizontal Directional Drilling

Horizontal directional drilling (HDD) was evaluated as an installation method for the entire length of the gas main. The cost to install the entire length of using HDD is substantially higher than open trench installation. Based on staging and future access requirements, the use of HDD would require the same amount of permanent clearing impacts as using alternative installation methods including open trench. Due to the large size of the proposed 16" gas main proposed, the temporary workspace needed to construct bore pits and set up appropriately sized drill rigs and associated equipment would require additional land clearing than what is needed for other installation methods. Using HDD installation next to the existing 8" gas main that parallels the proposed gas main creates a risk of damaging the existing utility. Additionally, the depth of pipelines installed using HDD prevents ready access for future repairs. The use of HDD for the entirety of the installation was not further evaluated based on the associated risks, the cost and because the wetland clearing impacts would still be required for HDD.

2.3.4.2 Alternative B: Open Trench Excavation and HDD (Preferred Alternative)

The location of the proposed gas main meets the project purpose while avoiding and minimizing impacts to aquatic resources to the maximum extent practicable. This alternative would incorporate a combination of open trench excavation and HDD installation. Open trench excavation is the preferred method because it allows the gas main to be installed only four to five feet in depth below the ground surface. Installing the gas main at a consistent shallow depth is a safer method and allows for the routine maintenance to be performed that is often required on transmission pipelines. Installation using open trench also significantly reduces the potential to impact the existing 8" gas pipeline in the ROW. The proposed temporary impacts to aquatic resources in areas containing emergent wetlands will be minimized by returning the excavated material to the open trench, re-grading to natural grade, and stabilizing immediately following installation of the utilities. Impacts to wetlands will be avoided in some areas using HDD as indicated on the permit drawings in Appendix A. An inadvertent release control plan associated with the HDD is included in Appendix F. The impacts to WOTUS, including wetlands will be minimized through the use of stormwater best management practices during construction

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activities to minimize sedimentation. Also, mats will be used as applicable to prevent rutting associated with mechanized clearing. Impacts to wetlands will be further minimized by implementing temporary clearing instead of permanent clearing in moist areas of disturbance.

2.3.4.2.1 Avoidance and Minimization

The following avoidance and minimization has been incorporated into this project:

- The site proposed project would avoid impacts to 6.3 acres of jurisdictional aquatic resources.
- The negligible amount of fill impacts (0.009 acres) associated with the project prevents smothering of organisms and disruption of periodic water inundation patterns.
- Most of the proposed impacts will be temporary.
- Stormwater best management practices will be implemented during construction activities to minimize sedimentation and confine suspended particulate/turbidity to a small area where settling or removal can occur
- HDD will be used to cross under Section 10 waters.
- Mats will be used as applicable to prevent rutting associated with mechanized clearing.
- The applicant will employ appropriate maintenance and operation on equipment or machinery, including adequate training, staffing, and working procedures.
- The applicant will use machinery and techniques that are especially designed to reduce damage to wetlands. This may include machines with specially designed wheels or tracks, and the use of mats under heavy machines to reduce wetland surface compaction and rutting.
- The applicant has designed access roads and channel spanning structures using culverts, open channels, and diversions that will pass both low and high-water flows, accommodate fluctuating water levels, and maintain circulation and faunal movement where applicable.
- The project will avoid sites having unique habitat or other value, including habitat of threatened or endangered species.

2.4 Alternatives Conclusion and Finding of LEDPA

The alternatives analysis included evaluation of the no action alternative, alternative sites, and onsite alternatives to avoid and minimize impacts to WOTUS, including wetlands. Reasonable and practicable alternatives that accomplish the overall project purpose have been evaluated and discussed in accordance with the Guidelines. Additionally, the information included in the analysis supports the rebuttal of the practicable alternatives presumptions. In consideration of the project purpose and need, and the site selection criteria, the development of the site using the proposed site design within the existing Dominion Energy ROW with expanded footprint represents the LEDPA.

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**3.0 WETLAND / WOTUS IMPACTS**

Jurisdictional WOTUS, including wetlands are defined by 33 C.F.R. § 328.3(b) and are protected by Section 404 of the CWA (33 U.S.C.A. § 1344), which is enforced by the USACE, Charleston District in South Carolina. Terracon delineated the wetlands within the project boundary on June 4, 2019 through June 6, 2019 and December 19, 2019. A JD Request package (SAC-2019-01427), dated August 21, 2019 was submitted to the USACE. The USACE completed a JD letter, dated May 27, 2020 and is included in Appendix B. Terracon visited the site and delineated wetlands within portions of a revised boundary on May 28, 2020. The revised boundary and delineation is depicted in the Depiction of Aquatic Resources Map included in Appendix B. The WOTUS identified during the Jurisdictional Determination process are depicted in Figure 1.

The Joint State and Federal Application Form and associated permit drawings depicting the proposed wetland impacts on the site are included in Appendix A.

The wetlands on the site drain east through Jefferies Creek, Mills Branch, Bigham Branch, Briar Branch, Barfield Mill Creek, Bullock Branch, and Unnamed Tributaries to the Great Pee Dee River. The wetlands that will be impacted are non-Section 10 freshwater wetlands. The overstory in the wetland areas primarily consists of loblolly pine (*Pinus taeda*), blackgum (*Nyssa sylvatica*), swamp tupelo (*Nyssa biflora*), bald cypress (*Taxodium distichum*), sweetgum (*Liquidambar styraciflua* L.), water oak (*Quercus nigra*), and red maple (*Acer rubrum*). The understory primarily consists of sweetgum (*Liquidambar styraciflua* L.), dogfennel (*Eupatorium capillifolium*), redbay (*Persea borbonia*), wax myrtle (*Morella cerifera*), smooth blackberry (*Rubus Canadensis*) and switchcane (*Persea borbonia*). The majority of the overstory is outside of the current easement and out of the impacted areas.

The proposed wetland impacts within the project footprint are shown on the permit drawings in Appendix A and are summarized in Table 2.

Table 2: Table of Impacts

Impact No.	Wetland Type	Distance to Receiving Water body (LF)	Purpose of Impact (road crossing, impoundment, flooding, etc)	Impact Size (acres)
1A	Jurisdictional Freshwater Wetland	~6,000	Temporary Excavation - Install Gas Main	0.11
1B	Jurisdictional Freshwater Wetland	~6,000	Permanent Clearing - Install Gas Main	0.03
2A	Jurisdictional Freshwater Wetland	~400	Temporary Excavation - Install Gas Main	5.14
2B	Jurisdictional Freshwater Wetland	~25	Permanent Clearing - Install Gas Main	1.8
2C	Jurisdictional Freshwater Wetland	~400	Temporary Clearing - Install Gas Main	5.64

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Impact No.	Wetland Type	Distance to Receiving Water body (LF)	Purpose of Impact (road crossing, impoundment, flooding, etc)	Impact Size (acres)
3B	Jurisdictional Freshwater Wetland	~900	Permanent Clearing - Install Gas Main	0.06
3C	Jurisdictional Freshwater Wetland	~900	Temporary Clearing - Install Gas Main	0.02
4B	Jurisdictional Freshwater Wetland	~1,700	Permanent Clearing - Install Gas Main	0.125
5	Jurisdictional Freshwater Wetland	~25	Permanent Clearing - Install Gas Main	0.089
6A	Jurisdictional Freshwater Wetland	~2,000	Temporary Excavation - Install Gas Main	0.49
6B	Jurisdictional Freshwater Wetland	~2,000	Permanent Clearing - Install Gas Main	0.12
6C	Jurisdictional Freshwater Wetland	~2,000	Temporary Clearing - Install Gas Main	0.31
7A	Jurisdictional Freshwater Wetland	~25	Temporary Excavation - Install Gas Main	0.27
7B	Jurisdictional Freshwater Wetland	~25	Permanent Clearing - Install Gas Main	0.094
7C	Jurisdictional Freshwater Wetland	~25	Temporary Clearing - Install Gas Main	0.140
8A	Jurisdictional Freshwater Wetland	~4,500	Temporary Excavation - Install Gas Main	0.18
8B	Jurisdictional Freshwater Wetland	~4,500	Permanent Clearing - Install Gas Main	0.042
9A	Jurisdictional Freshwater Wetland	~4,500	Temporary Excavation - Install Gas Main	0.013
9B	Jurisdictional Freshwater Wetland	~4,500	Permanent Clearing - Install Gas Main	0.017
10A	Jurisdictional Freshwater Wetland	~2,800	Temporary Excavation - Install Gas Main	0.007
10B	Jurisdictional Freshwater Wetland	~2,800	Permanent Clearing - Install Gas Main	0.014
11A	Jurisdictional Freshwater Wetland	~2,600	Temporary Excavation - Install Gas Main	0.02
11B	Jurisdictional Freshwater Wetland	~2,600	Permanent Clearing - Install Gas Main	0.036
12A	Jurisdictional Freshwater Wetland	~1,000	Temporary Excavation - Install Gas Main	0.011
12B	Jurisdictional Freshwater Wetland	~1,000	Permanent Clearing - Install Gas Main	0.015
13A	Jurisdictional Freshwater Wetland	~25	Temporary Excavation - Install Gas Main	0.16
13B	Jurisdictional Freshwater Wetland	~25	Permanent Clearing - Install Gas Main	0.04

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Impact No.	Wetland Type	Distance to Receiving Water body (LF)	Purpose of Impact (road crossing, impoundment, flooding, etc)	Impact Size (acres)
14A	Jurisdictional Freshwater Wetland	~50	Temporary Excavation - Install Gas Main	0.008
14B	Jurisdictional Freshwater Wetland	~50	Permanent Clearing - Install Gas Main	0.005
15A	Jurisdictional Freshwater Wetland	~700	Temporary Excavation - Install Gas Main	0.13
15B	Jurisdictional Freshwater Wetland	~700	Permanent Clearing - Install Gas Main	0.014
16A	Jurisdictional Freshwater Wetland	~600	Temporary Excavation - Install Gas Main	0.017
16B	Jurisdictional Freshwater Wetland	~600	Permanent Clearing - Install Gas Main	0.005
16C	Jurisdictional Freshwater Wetland	~600	Temporary Clearing - Install Gas Main	0.016
17A	Jurisdictional Freshwater Wetland	~25	Temporary Excavation - Install Gas Main	0.41
17B	Jurisdictional Freshwater Wetland	~25	Permanent Clearing - Install Gas Main	0.10
18A	Jurisdictional Freshwater Wetland	~300	Temporary Excavation - Install Gas Main	0.04
18B	Jurisdictional Freshwater Wetland	~300	Permanent Clearing - Install Gas Main	0.007
19A	Non-wetlands Water (Freshwater Tributary)	~1,500	Temporary Excavation - Install Gas Main	0.019
19B	Non-wetlands Water (Freshwater Tributary)	~1,500	Permanent Clearing - Install Gas Main	0.002
19C	Non-wetlands Water (Freshwater Tributary)	~1,500	Permanent Fill - Install Rip Rap to stabilize bank	0.0045
19D	Non-wetlands Water (Freshwater Tributary)	~1,500	Temporary Clearing - Install Gas Main	0.008
20A	Jurisdictional Freshwater Wetland	~3,500	Temporary Excavation - Install Gas Main	0.14
20B	Jurisdictional Freshwater Wetland	~3,500	Permanent Clearing - Install Gas Main	0.03
21A	Jurisdictional Freshwater Wetland	~5,000	Temporary Excavation - Install Gas Main	0.17
21B	Jurisdictional Freshwater Wetland	~5,000	Permanent Clearing - Install Gas Main	0.05
22A	Jurisdictional Freshwater Wetland	~5,500	Temporary Excavation - Install Gas Main	0.19

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Impact No.	Wetland Type	Distance to Receiving Water body (LF)	Purpose of Impact (road crossing, impoundment, flooding, etc)	Impact Size (acres)
22B	Jurisdictional Freshwater Wetland	~5,500	Permanent Clearing - Install Gas Main	0.05
22C	Jurisdictional Freshwater Wetland	~5,500	Temporary Clearing - Install Gas Main	0.12
23A	Jurisdictional Freshwater Wetland	~6,000	Temporary Excavation - Install Gas Main	0.12
23B	Jurisdictional Freshwater Wetland	~6,000	Permanent Clearing - Install Gas Main	0.04
24A	Jurisdictional Freshwater Wetland	~4,000	Temporary Excavation - Install Gas Main	0.06
24B	Jurisdictional Freshwater Wetland	~4,000	Permanent Clearing - Install Gas Main	0.02
25A	Jurisdictional Freshwater Wetland	~25	Temporary Excavation - Install Gas Main	0.25
25B	Jurisdictional Freshwater Wetland	~25	Permanent Clearing - Install Gas Main	0.07
26A	Jurisdictional Freshwater Wetland	~400	Temporary Excavation - Install Gas Main	0.15
26B	Jurisdictional Freshwater Wetland	~400	Permanent Clearing - Install Gas Main	0.05
26C	Jurisdictional Freshwater Wetland	~400	Temporary Clearing - Install Gas Main	0.08
27A	Non-wetlands Water (Freshwater Tributary)	~2,500	Temporary Excavation - Install Gas Main	0.009
27B	Non-wetlands Water (Freshwater Tributary)	~2,500	Permanent Clearing - Install Gas Main	0.002
27C	Non-wetlands Water (Freshwater Tributary)	~2,500	Temporary Clearing - Install Gas Main	0.003
28A	Jurisdictional Freshwater Wetland	~2,000	Temporary Excavation - Install Gas Main	0.044
28B	Jurisdictional Freshwater Wetland	~2,000	Permanent Clearing - Install Gas Main	0.013
29	Jurisdictional Freshwater Wetland	~3,200	Temporary Excavation - Install Gas Main	0.03
30A	Jurisdictional Freshwater Wetland	~5,000	Temporary Excavation - Install Gas Main	0.19
30B	Jurisdictional Freshwater Wetland	~5,000	Permanent Clearing - Install Gas Main	0.05
31	Jurisdictional Freshwater Wetland	~3,500	Permanent Fill - Install Road Crossing w/ Culvert & Rip Rap	0.0017

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Impact No.	Wetland Type	Distance to Receiving Water body (LF)	Purpose of Impact (road crossing, impoundment, flooding, etc)	Impact Size (acres)
32	Jurisdictional Freshwater Wetland	~3,500	Permanent Fill - Install Road Crossing w/ Culvert & Rip Rap	0.0024
Total Wetland Impacts (acres)				17.714

4.0 PROPOSED MITIGATION

Section 404 of the CWA requires permits for the discharge of dredged or fill material into WOTUS, including wetlands. Jurisdictional wetlands are defined by 33 C.F.R. § 328.3(b) and are protected by Section 404 of the CWA (33 U.S.C.A. § 1344), which is enforced by the USACE, Charleston District in South Carolina. In accordance with Section 404 of the Clean Water Act, compensatory mitigation is necessary to offset unavoidable impacts to aquatic resource functions and services and to meet the programmatic goal of “no overall net loss” of aquatic resource functions and services.

Based on the USACE 2017 NWP 12 Decision Document: “For utility line activities crossing a single waterbody more than one time at separate and distant locations, or multiple waterbodies at separate and distant locations, each crossing is considered a single and complete project for purposes of NWP authorization”.

The proposed impacts associated with the project do not conflict with Section 23(c) of the 2017 Nationwide Permit General Conditions or the Final Regional Conditions for 16 Nationwide Permits in Charleston District, dated March 15, 2021. No mitigation is proposed because the project will not result in more than 1/10-acre of discharge of dredged or fill material into WOTUS, including wetlands at the proposed impact locations. Additionally, the project will not result in more than 0.005-acre loss of intermittent and/or perennial stream bed for a single crossing. Clearing impacts are the only permanent impacts associated with the project over 1/10-acre.

5.0 OTHER CONSIDERATIONS

The USACE Charleston District bases the decision to issue a permit for WOTUS impacts on an evaluation of a variety of cumulative factors. These factors include: conservation, economics, aesthetics, wetlands, historic properties, fish and wildlife values, flood hazards, flood plain values, land use, navigation, shoreline erosion and accretion, recreation, water supply and conservation, water quality, energy needs, safety, food and fiber production, general environmental concerns, and the needs and welfare of the people. The above listed factors are discussed below. Factors in which the applicant believes to be more relevant to the project are discussed in more detail.

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**5.1.1 Conservation**

It is well known that fully functional wetland systems contribute to the environment both directly and indirectly. The applicant acknowledges that wetland protection is imperative for a sustainable future. The clearing impacts proposed for the project will not result in a loss of wetlands. Instead the permanent clearing impacts will result in emergent wetland system with significant ecological value.

5.1.2 Economics

Based on the International Gas Union⁵ the natural gas industry is a major contributor to the GDP of numerous countries. In 2008 natural gas production in the U.S. added \$385 billion to the country's GDP. The industry is large-scale that employs thousands and generates millions of dollars. Natural gas also enables other industries, predominantly those that are energy exhaustive.

According to the International Gas Union a study by the Center for Global Development, discovered that the higher use of natural gas for electricity could help boost some countries out of poverty by providing greater access to affordable and reliable power.

The energy supply demand is expected to rapidly increase in the corridor between Florence and Conway in Florence County and the proposed project is anticipated to support this growth and have an overall positive impact to the economy.

5.1.3 Aesthetics

The majority of the project footprint will take place in a cleared maintained easement. The areas outside of the easement includes predominately undeveloped woodlands and agricultural land. The project footprint will also be buffered by woodlands and agriculture land ranging from 300 to 3,000 feet wide from most residents and Old River Road. The woodlands and agriculture land buffer will provide higher quality aesthetics.

5.1.4 Floodplain Values

According to the Federal Emergency Management Administration (FEMA) Flood Insurance Rate Map (FIRM), the site is located within a designated floodplain or a floodway. According to the FIRM 45041C0305E, 45041C0310E, 45041C0320E, 45041C0410E, 45041C0430E, and 45041C0440E, all dated 3/16/2014, the site is designated as Zone X and A. Zone X is defined as an area determined to be outside the 0.2% annual chance floodplain. Zone A is defined as an area determined to be subject to flooding by the 1% annual chance flood. Zone A does not have a base flood elevation determined. The proposed project will have a no effect on floodplain values.

⁵ <https://www.igu.org/natural-gas-powers-economic-growth>

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**5.1.5 Flood Hazards**

The applicant will implement best management practices that will minimize erosion and migration of sediments on and off the project site during and after construction. Additionally, land disturbance activity will comply with the South Carolina National Pollutant Discharge Elimination System (NPDES) General Permit for Storm Water Discharges from Large and Small Construction Activities (SCR100000) as applicable. These practices will include the use of appropriate grading and sloping techniques and erosion prevention and sediment control measures capable of preventing erosion, migration of sediments, and bank failure. Once the project is initiated, it will be carried to completion in an expeditious manner, minimizing the period of disturbance to the environment.

Temporary best management practices such as silt fence and/or other diversionary structures will be used during construction as applicable. Permanent stabilization of embankments will contain appropriately sized rip-rap over geotextile liner or other similar approved permanent erosion control features where applicable. Temporary and permanent stormwater controls may be used to minimize sedimentation and erosion and minimize impact to the wetland areas.

5.1.6 Land Use

Land use involves the management and modification of land into built environment. Zoning ordinances are established by municipalities to direct future growth and development in order to serve the general welfare, by keeping certain land uses in proximity to one another.

The alternative sites evaluated for the project contain land use designations such as agricultural lands, industrial, woodlands, wetlands, and other resources. These lands provide much of the character that makes Florence County an attractive place to live and work.

The proposed gas main installation is consistent with this zoning and its requirements. On this basis, the proposed project will have a positive long-term effect on land use.

5.1.7 Navigation

The proposed project would have no effect on navigation.

5.1.8 Shoreline Erosion and Accretion

The proposed project would have no effect on shoreline erosion or accretion.

5.1.9 Recreation

The proposed project will have a no effect on recreation. The gas main installation on the site will not create, destroy, or restrict access to any parks or recreational facilities on or near the project site.

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**5.1.10 Water Quality and Supply**

The site is located in the Middle Pee Dee River Watershed [Hydrological Unit Code (HUC) 03040201]. The waters of the U.S. (WOTUS), including wetlands on the site drain east through Jeffries Creek, Mills Branch, Bigham Branch, Briar Branch, Barfield Mill Creek, Bullock Branch, and Unnamed Tributaries to the Great Pee Dee River. Based on a review of the SDHEC Final CWA Section 303(d) List of Water Quality Limited Segments⁶ Jeffries Creek and Great Pee Dee River are listed on the 2016 South Carolina List of Impaired Waters by 12-Digit HUC.

The upper portion of the project site is located within Watershed 03040201-09. Jeffries Creek, Pye Branch, and Middle Swamp are classified as FW* (dissolved oxygen not less than 4 mg/l and pH between 5.0 and 8.5) and the remaining streams in the watershed are classified as FW (Freshwater). Jeffries Creek accepts drainage from Beaverdam Creek, Gulley Branch, Pye Branch, Middle Swamp, Eastman Branch, and Cane Branch. Next Polk Swamp enters the system, followed by Middle Branch, Long Branch, Boggy Branch, More Branch, and Willow Creek. The Jeffries Creek Watershed then drains into the Great Pee Dee River. There are a total of 229.5 stream miles and 353.2 acres of lake waters in this watershed. According to the SCDHEC Watershed Atlas⁷ there are a total of five SCDHEC water quality monitoring stations along Jeffries Creek. The nearest water quality monitoring station from the site is PD-231 and is located approximately 4.5 river miles upstream from the site. At station PD-231, aquatic life and recreational uses are fully supported; however, there are trends in significant decrease in dissolved oxygen concentrations as well as trends in increasing five-day biological oxygen demands, turbidity, and fecal coliform bacteria.

The majority of the project site is located in the Great Pee Dee River Watershed (03040201-12). All waters are classified as FW in the watershed. This section of the Great Pee Dee River accepts drainage from its upper reaches, along with Mill Branch, Bigham Branch, Barfield Mill Creek, the Catfish Creek Watershed, Bull Swamp, and Mulyns Creek. Additionally, there are oxbow lakes draining into the river that include the Dead River, Graves Lake, and Honey Lake. There are a total of 100.4 stream miles and 115.5 acres of lake waters in this watershed. According to the SCDHEC Watershed Atlas⁸ there are a total of three SCDHEC water quality monitoring stations along this section of the Great Pee Dee River. This section is a blackwater system which is characterized by naturally low dissolved oxygen conditions. Approximately 0.5 river miles downstream from the site water quality monitoring stations RS-10365 and RS-08237 fully support aquatic life and recreational uses. At water quality monitoring station PD-076 approximately 3 river miles downstream from the site aquatic life uses are fully supported. Dissolved oxygen excursions occurred; however, they are typical values seen in blackwater systems and were considered natural (not standard violations).

⁶ http://www.scdhec.gov/HomeAndEnvironment/Docs/tmdl_16-303d.pdf

⁷ <https://gis.dhec.sc.gov/watersheds/>

⁸ <https://gis.dhec.sc.gov/watersheds/>

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As previously discussed, the proposed project would result in unavoidable impacts to wetlands due to the proposed gas main installation on the site. Additional information regarding the impacts to wetlands and WOTUS and mitigation is documented in Section 3.0 and 4.0 of this document.

Construction activities will have temporary negative impacts on water quality when the project site is being cleared, graded, and prepared for development. However, potential impacts will be minimized through the use of Best Management Practices (BMPs) specified as conditions by SCDHEC in its Water Quality Certification issued to address water quality criteria specific to this project. The proposed project will have a negligible long-term effect on water quality and supply.

5.1.11 Energy Needs

There is an increasing demand for natural gas in eastern South Carolina due to residential, commercial and industrial growth. The proposed project would support the growth in the area by providing the additional capacity and flexibility to meet the current and anticipated customer demands for natural gas as an energy supply.

5.1.12 Safety

The proposed project would have no long-term effect on safety. The construction and operation of the project will be required to comply with the appropriate Occupational Safety and Health Administration (OSHA) guidelines regarding employee safety. The proposed project is not anticipated to cause safety issues.

5.1.13 Food and Fiber Production

The proposed project would have no effect on food and fiber production.

5.1.14 Mineral Needs

The proposed project will have no effect on mineral needs.

5.1.15 Consideration of Property Ownership

Based on a review of information obtained from the Florence County assessor's records, the majority of the project site is within a current Dominion Energy ROW that transects multiple parcels with multiple land owners. Dominion Energy (the applicant), is supportive of the proposed project. It is not anticipated that the adjoining property owners to the ROW would be opposed to the proposed project. Adjoining property owners who might be affected by the proposed project will have an opportunity to comment on the proposed project during the public notice period.

5.1.16 General Environmental Concerns

No environmental concerns have been identified.

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**5.1.17 The Needs and Welfare of the People**

Dominion Energy's primary mission has always been, and continues to be, to serve their customers safely and reliably; strengthen their communities; reward their shareholders; minimize environmental impacts and live their values. The proposed gas main installation will have a positive effect on the needs and welfare of people.

5.1.18 Environmental Justice

Executive Order (EO) 12898 (Federal Actions to Address Environmental Justice in Minority Populations and Low-Income Populations) was issued in 1994. Its purpose is to focus federal attention on the environmental and human health effects of federal actions on minority and low-income populations with the goal of achieving environmental protection for all communities. The EO directs federal agencies to identify and address the disproportionately high and adverse human health or environmental effects of agency actions on minority and low-income populations, to the greatest extent practicable and permitted by law. The order also directs each agency to develop a strategy for implementing environmental justice. The order is also intended to promote nondiscrimination in federal programs that affect human health and the environment, as well as provide minority and low-income communities access to public information and public participation⁹. The proposed project is expected to have a positive impact on minority populations due to the creation of jobs.

5.1.19 Federally Protected Species

Terracon prepared a Threatened and Endangered Species report for the site dated, July 2019. A field survey was conducted within the site boundaries and immediate vicinity of the site on June 4, 2019 through June 6, 2019 by Terracon. The threatened and endangered species survey was completed to identify suitable habitat for federally threatened and endangered species protected by the Federal Endangered Species Act (ESA) of 1973.

Based on the "no effect" conclusions of this assessment, further coordination with USFWS is not required. The USFWS South Carolina Ecological Services Field Office maintains a "clearance letter", that applies to all projects in which a "no effect" determination has been made. This clearance letter serves as the USFWS concurrence with the conclusions of habitat assessments. A copy of the Threatened and Endangered Survey report for the site, which includes the clearance letter is included in Appendix D.

⁹ *Federal Actions to Address Environmental Justice in Minority Populations and Low-Income Populations*, 59 FR 7629; February 16, 1994

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**5.1.20 Fish and Wildlife Values**

The project site contains cleared land and wooded land. Portions of the cleared land consisted of agricultural land. The wooded land on the site consisted of palustrine shrub scrub wetlands, non-alluvial waters, and mixed pine hardwoods which all provide habitat for wildlife species. The construction of this project will have a minimal long-term adverse effect on wildlife that use the habitat.

5.1.21 Cultural Resources

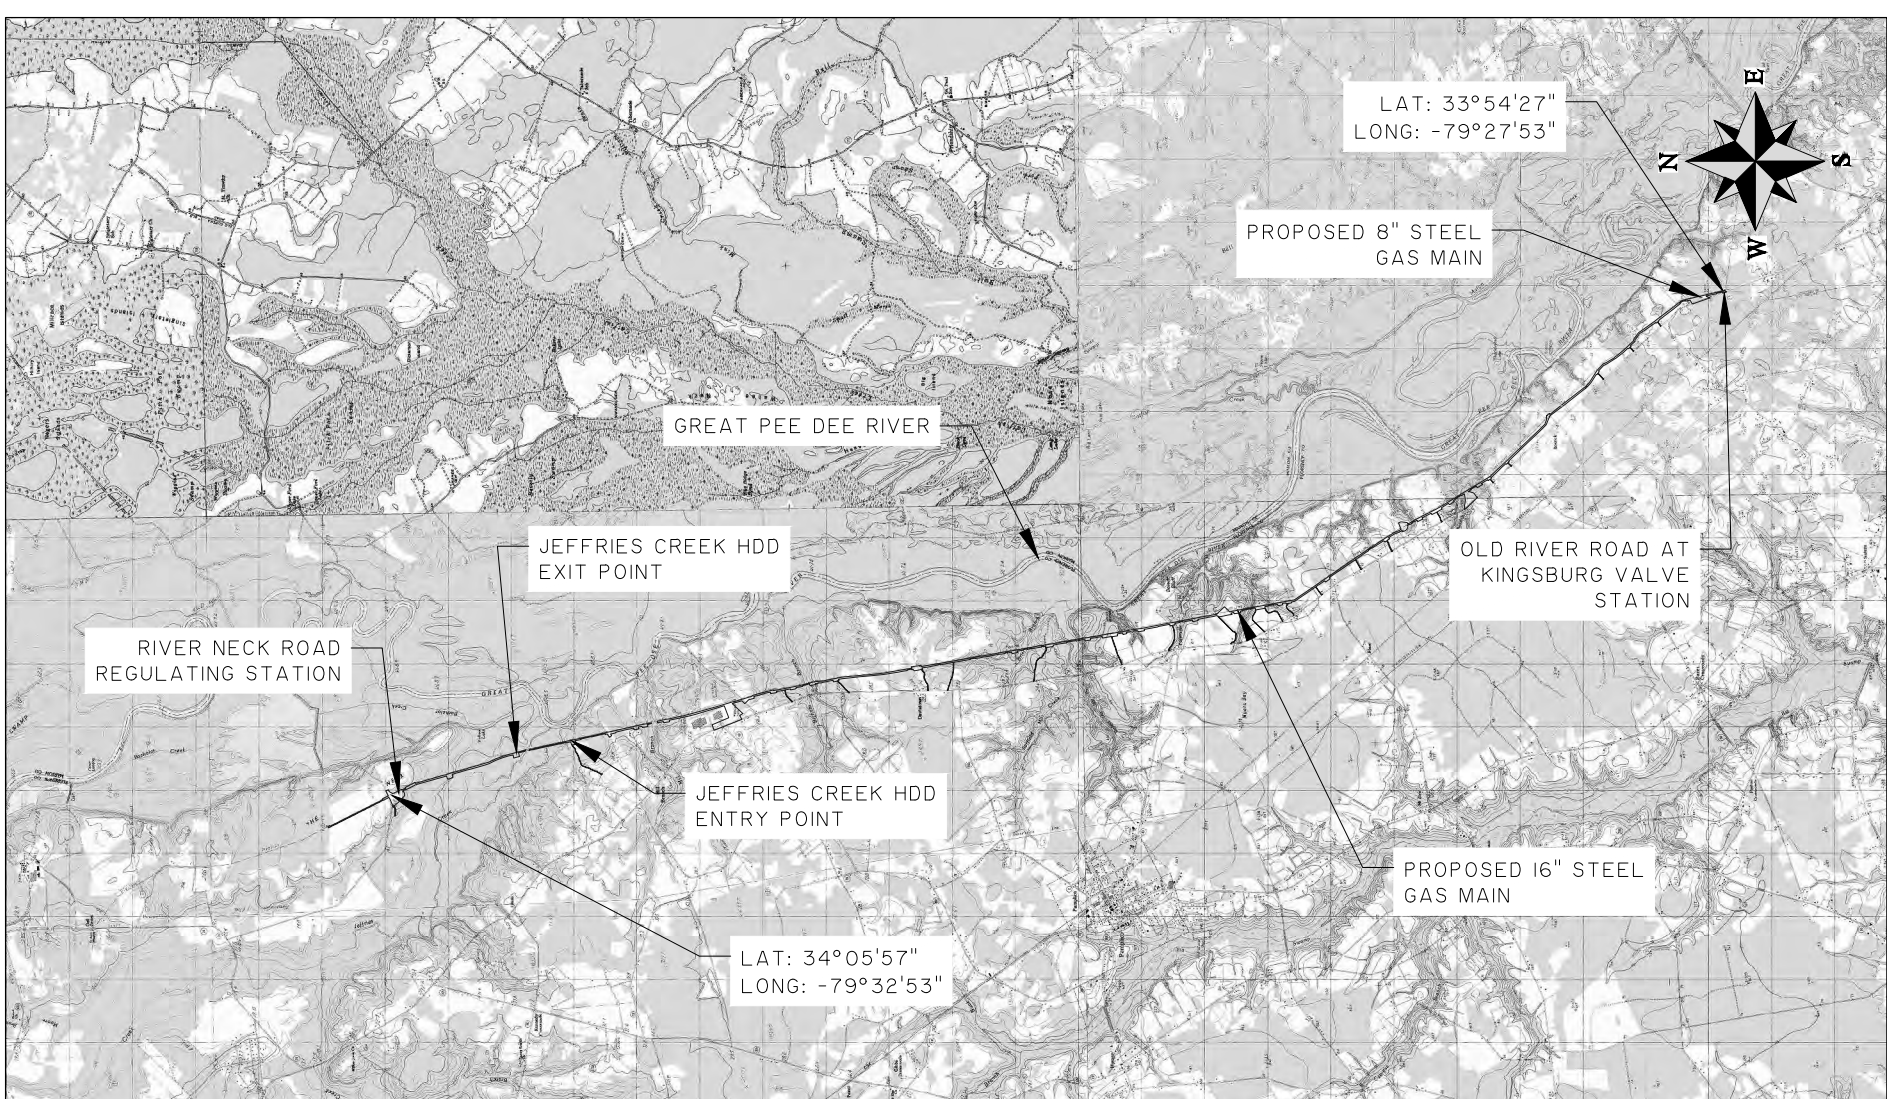
See Appendix E for a copy of the report and the SHPO coordination.

Terracon has completed Phase I and II investigations at the River Neck to Kingsburg Line in Florence County, South Carolina. As a result of the Phase I investigations Terracon identified 16 new archaeological sites (FC-1 through FC 16) along approximately 11.61 miles of the proposed gas line. Of these resources, two sites, FC-3 and FC-10 (Figures 2 and 3), were believed to be potentially significant and Terracon recommended Phase II testing at these two sites to Thomas & Hutton. The work was authorized and based on the results of the Phase II testing sites FC-3 and FC-10 will both be recommended as being eligible for inclusion in the National Register of Historic Places (NRHP).

In addition to the 11.61 miles of Phase I survey, Terracon conducted Phase I/II investigations of nine previously recorded sites along 2.89 miles of the proposed gas line that had been previously surveyed in 1984 and 2006. To help relocate these sites, Terracon excavated shovel tests at 30-meter intervals across the reported areas containing the sites. However, only two sites, 38FL116/124/191 and 38FL148/155, could be relocated (Figures 4 and 5). Based on the Phase II testing and previous work conducted at these sites, site 38FL116/124/191 is considered to be eligible for the NRHP. Site 38FL148/155 was previously determined to be eligible for the NRHP; however, it is Terracon's opinion that the portion of the site within the ROW does not contribute to the site's significance.

The architectural survey identified five historic structures and one cemetery (the Epheseus Cemetery) within the proposed Area of Potential Effects (APE). All of these resources will be recommended as ineligible for the NRHP.

Based on these results, Terracon recommends avoiding sites 38FL116/124/191, FC-3, and FC-10. If this is not possible, then Dominion Energy South Carolina should begin consultation with the State Historic Preservation Office (SHPO) and other consulting parties on ways to minimize or mitigate the potential adverse effects to these sites.



RIVER NECK TO KINGSBURG 16" GAS MAIN

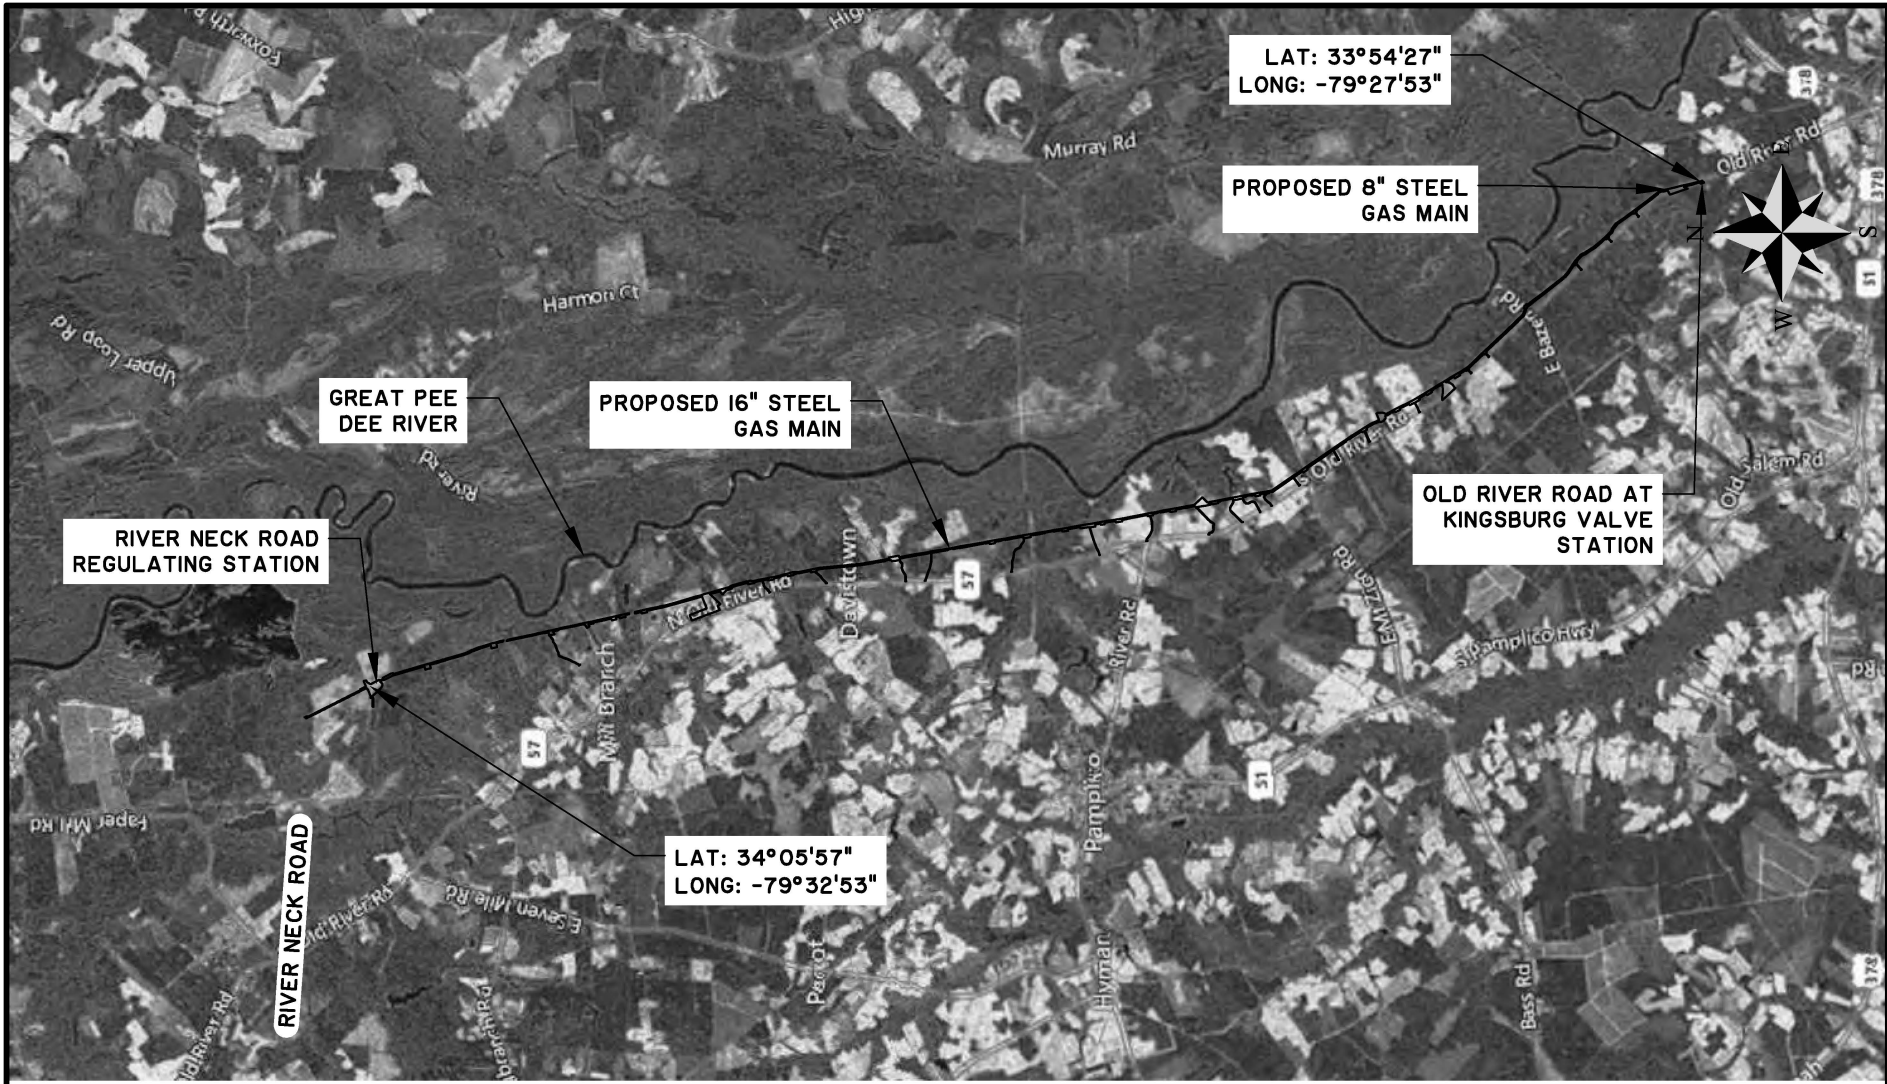
WETLAND IMPACT SITE MAP

CLIENT:
DOMINION ENERGY

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DATE: 5/27/2020	REVIEWED BY: JRS	SCALE: 1" = 1000'
JOB NUMBER: J-27886.0000		



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RIVER NECK TO KINGSBURG 16" GAS MAIN

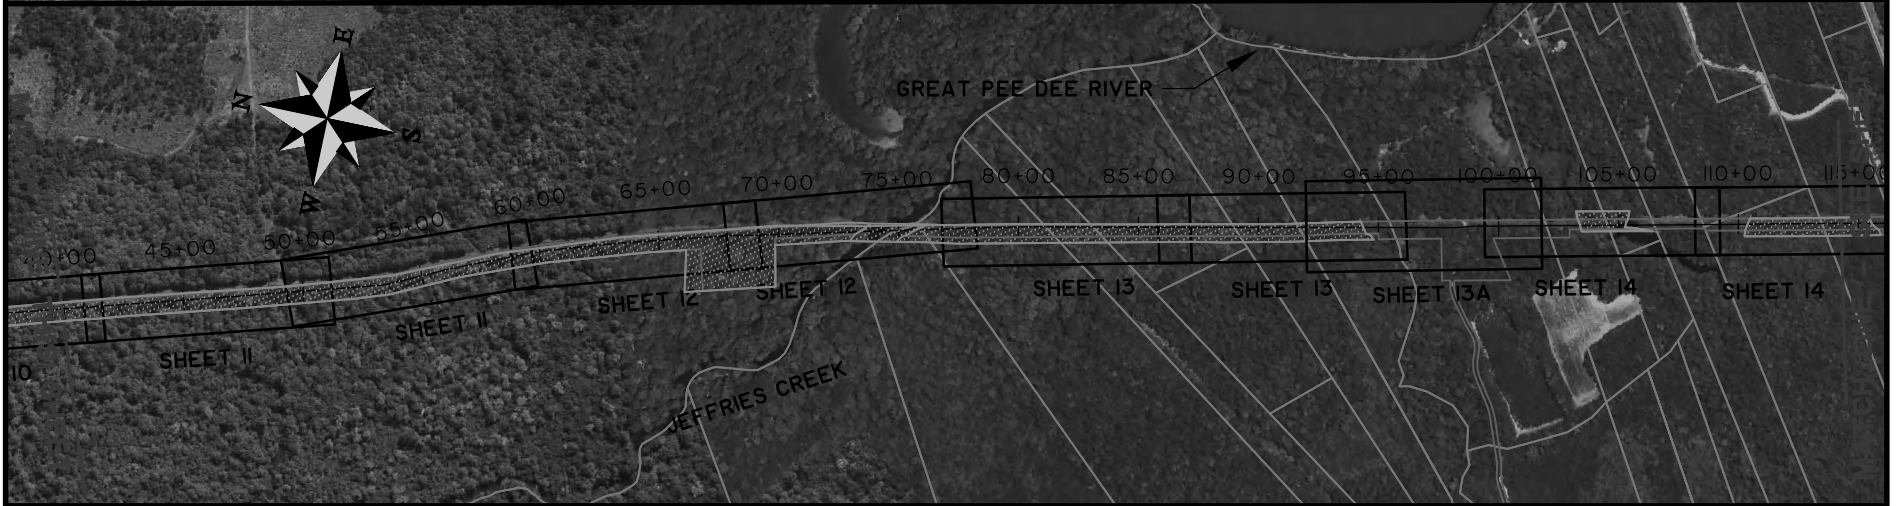
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WETLAND IMPACT LOCATION MAP

CLIENT:
DOMINION ENERGY

LOCATION: FLORENCE COUNTY, SC	DATE: 04/21/21	DRAWN BY: DNF	SHEET: 2
JOB NUMBER: J-27886.0000	REVIEWED BY: JRS	SCALE: 1" = 10000'	



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RIVER NECK TO KINGSBURG 16" GAS MAIN

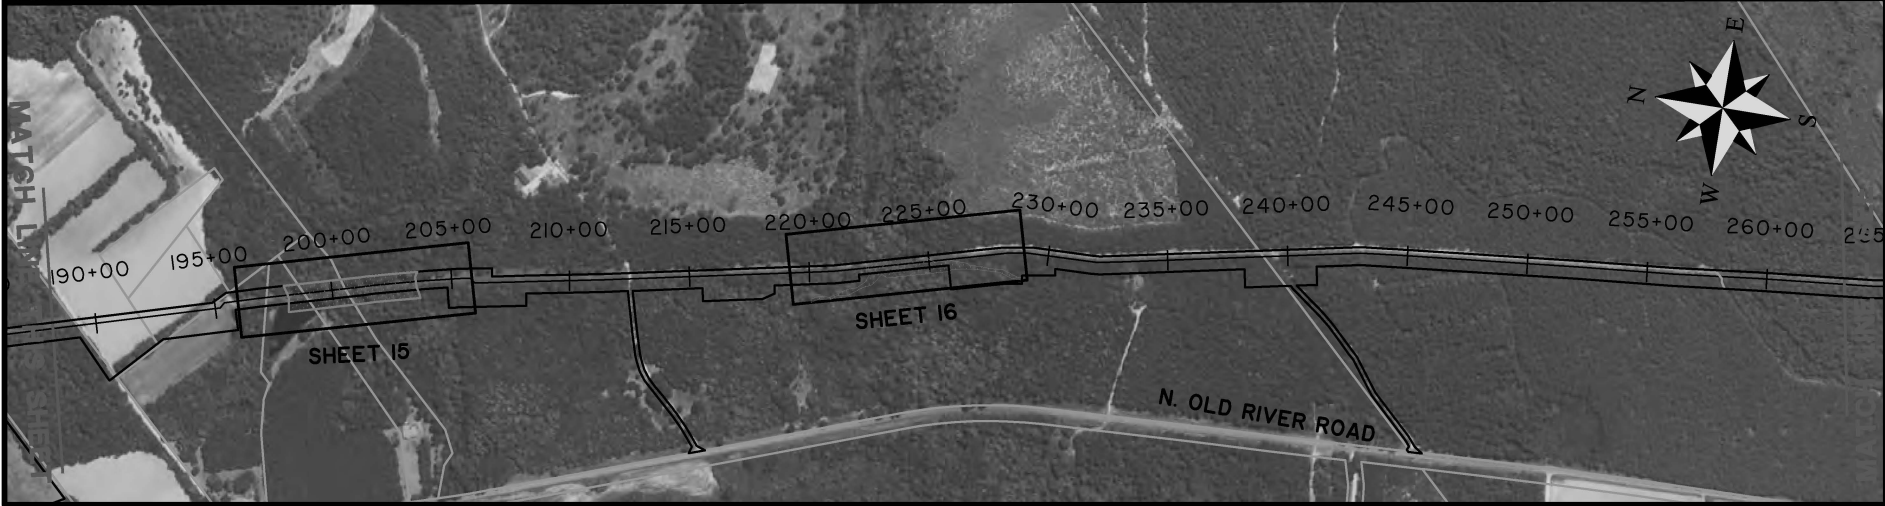
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JOB NUMBER: J-27886.0000		



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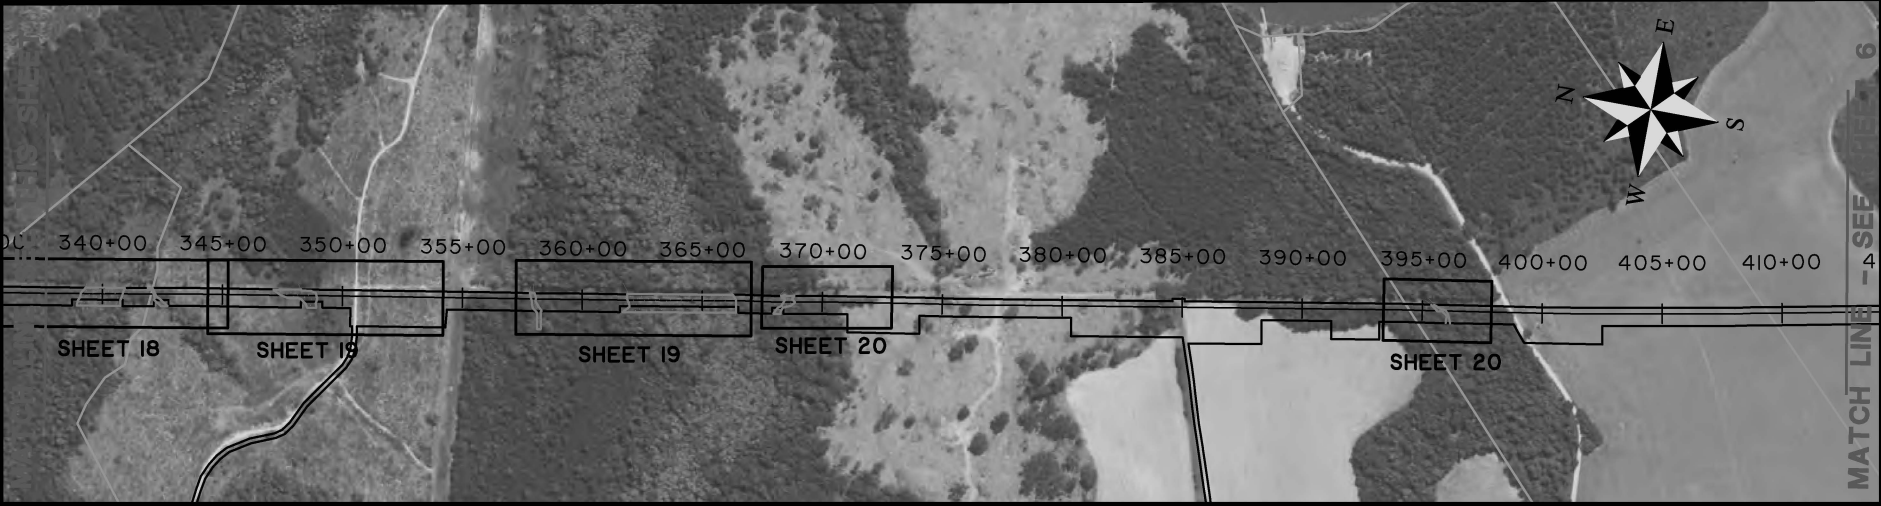
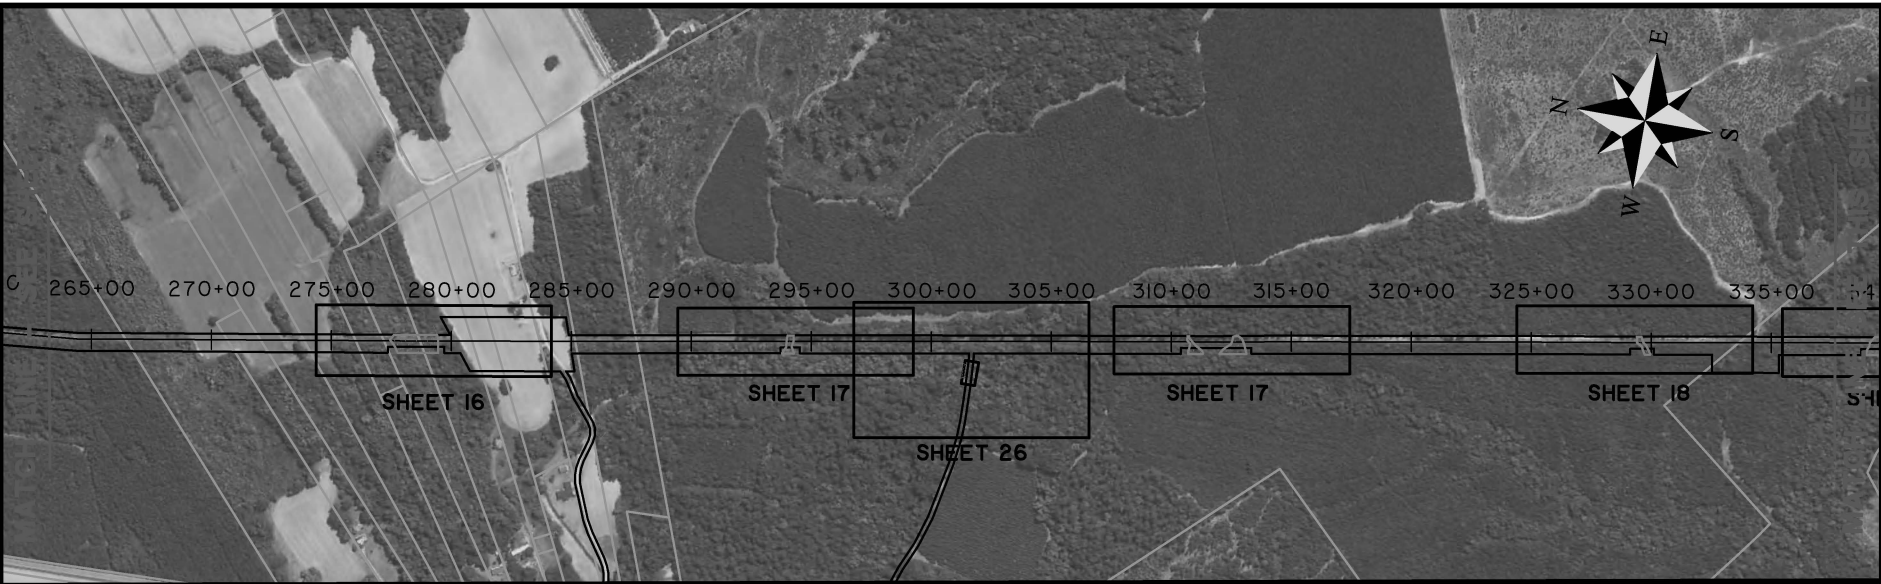
RIVER NECK TO KINGSBURG 16" GAS MAIN

SHEET INDEX
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DOMINION ENERGY

LOCATION: FLORENCE COUNTY, SC
 DATE: 04/21/21 DRAWN BY: DNF SHEET: 4
 JOB NUMBER: J-27886.0000 REVIEWED BY: JRS SCALE: 1" = 800'



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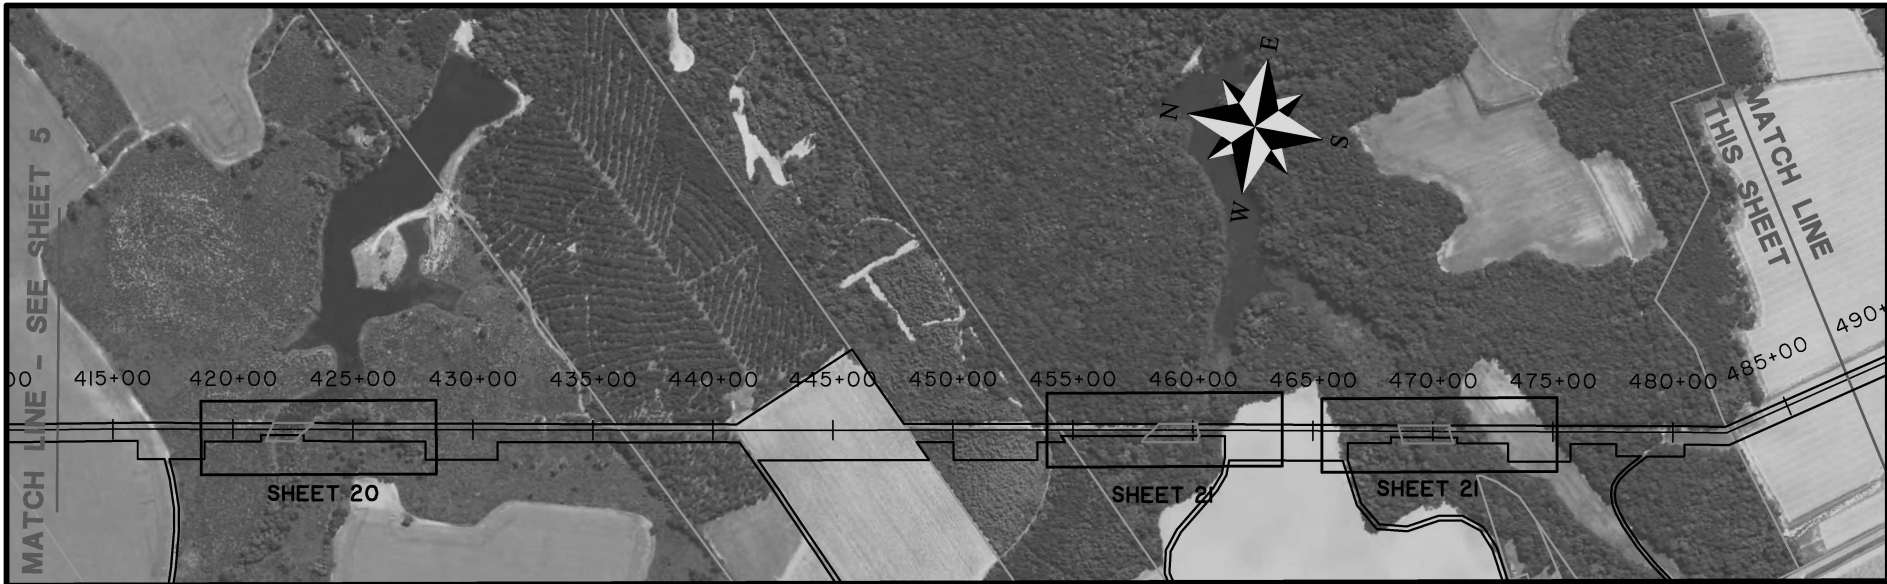
RIVER NECK TO KINGSBURG 16" GAS MAIN

SHEET INDEX
 CLIENT:
DOMINION ENERGY

LOCATION: FLORENCE COUNTY, SC
 DATE: 04/21/21 DRAWN BY: DNF SHEET: 5
 JOB NUMBER: J-27886.0000 REVIEWED BY: JRS SCALE: 1" = 800'



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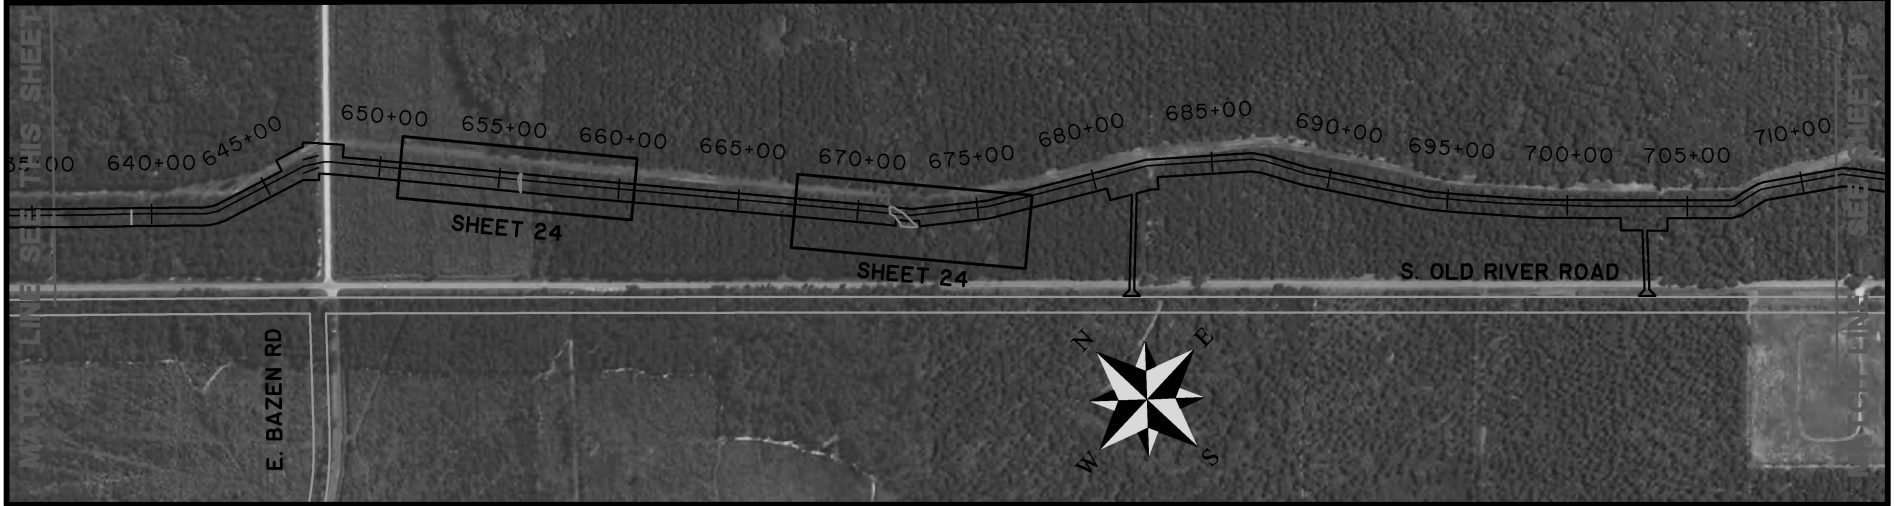
RIVER NECK TO KINGSBURG 16" GAS MAIN

SHEET INDEX
 CLIENT:
DOMINION ENERGY

LOCATION: FLORENCE COUNTY, SC
 DATE: 04/21/21 DRAWN BY: DNF SHEET: 6
 JOB NUMBER: J-27886.0000 REVIEWED BY: JRS SCALE: 1" = 800'



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RIVER NECK TO KINGSBURG 16" GAS MAIN

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CLIENT:
DOMINION ENERGY

LOCATION: FLORENCE COUNTY, SC	DRAWN BY: DNF	SHEET: 7
DATE: 04/21/21	REVIEWED BY: JRS	SCALE: 1" = 800'
JOB NUMBER: J-27886.0000		



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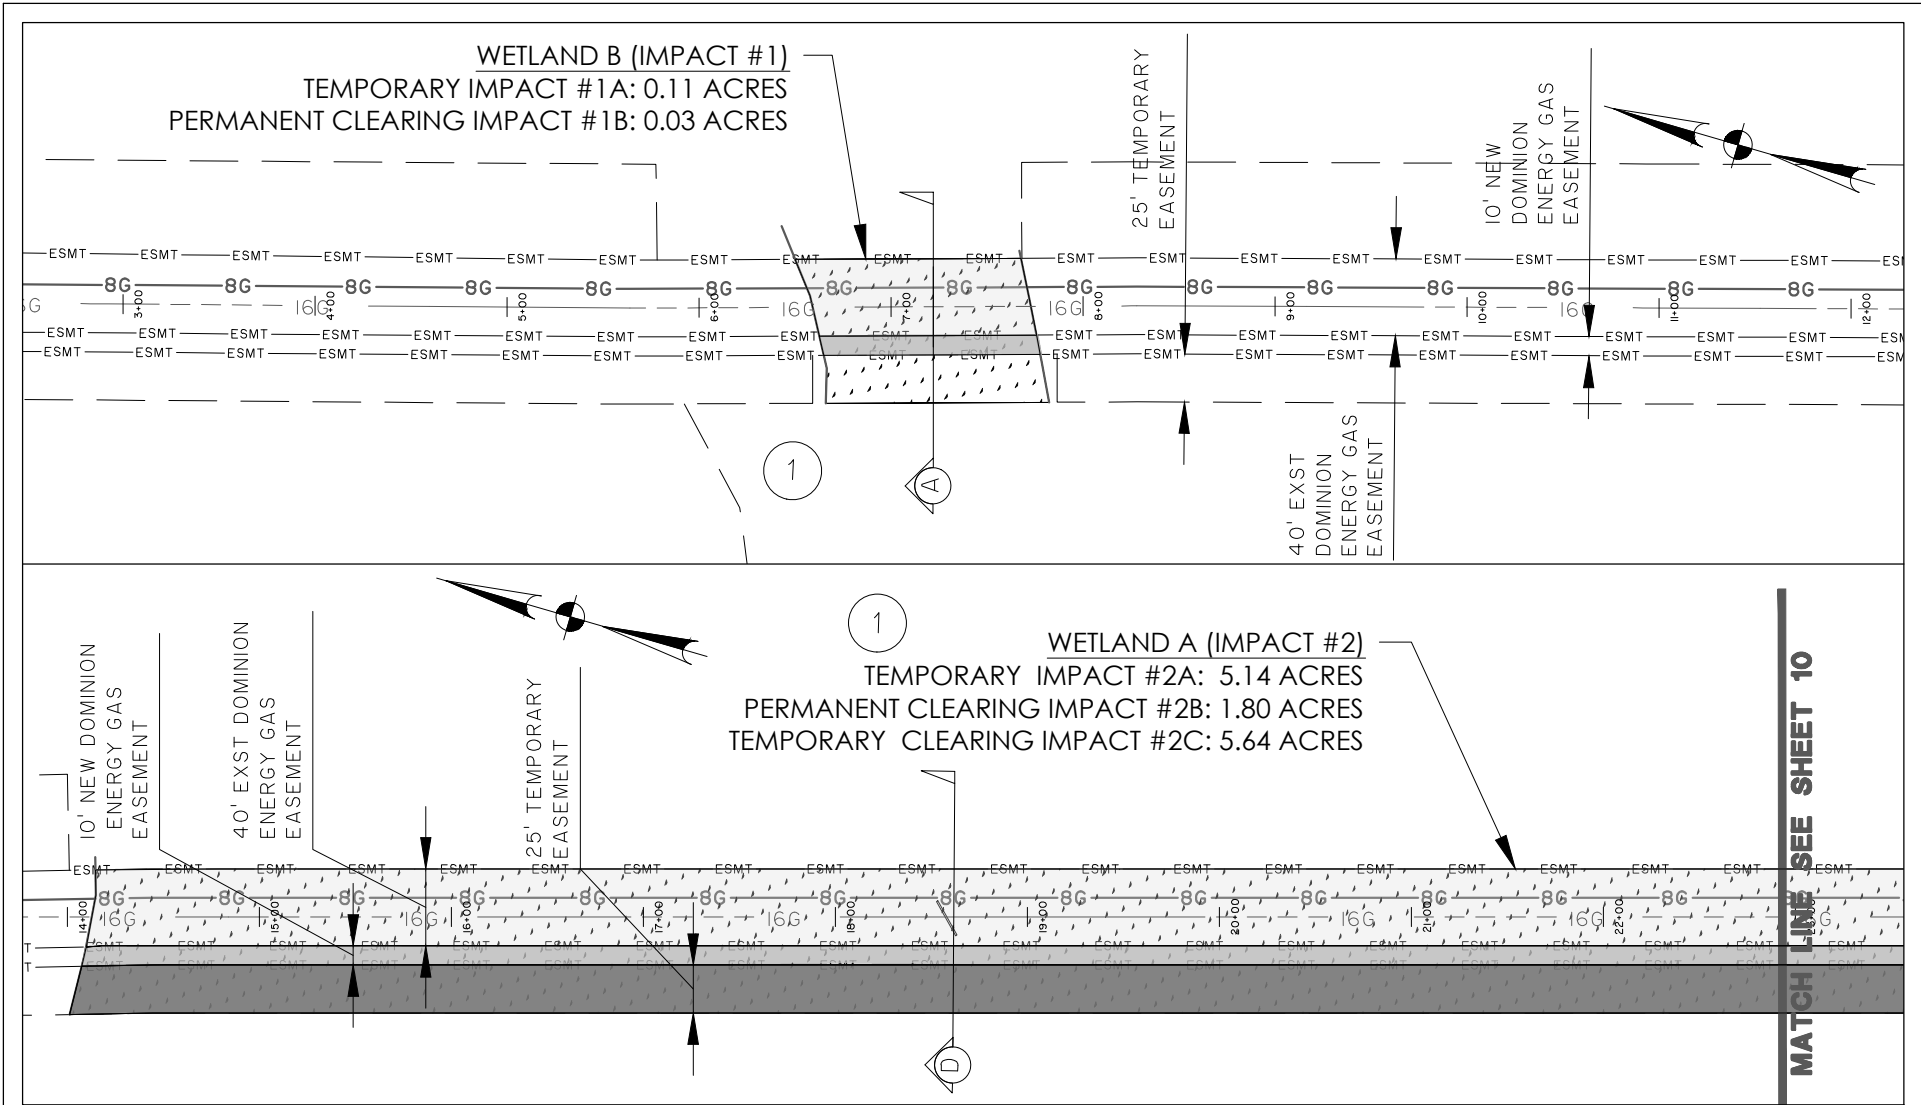
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LOCATION: FLORENCE COUNTY, SC
 DATE: 04/21/21 DRAWN BY: DNF SHEET: 8
 JOB NUMBER: J-27886.0000 REVIEWED BY: JRS SCALE: 1" = 800'



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LEGEND

	TEMPORARY IMPACT
	PERMANENT CLEARING IMPACT
	TEMPORARY CLEARING IMPACT
	PROPOSED 16" GAS LINE (OPEN-CUT)
	PROPOSED 16" GAS LINE (HDD)
	WETLAND
	DOMINION ENERGY PERMANENT EASEMENT

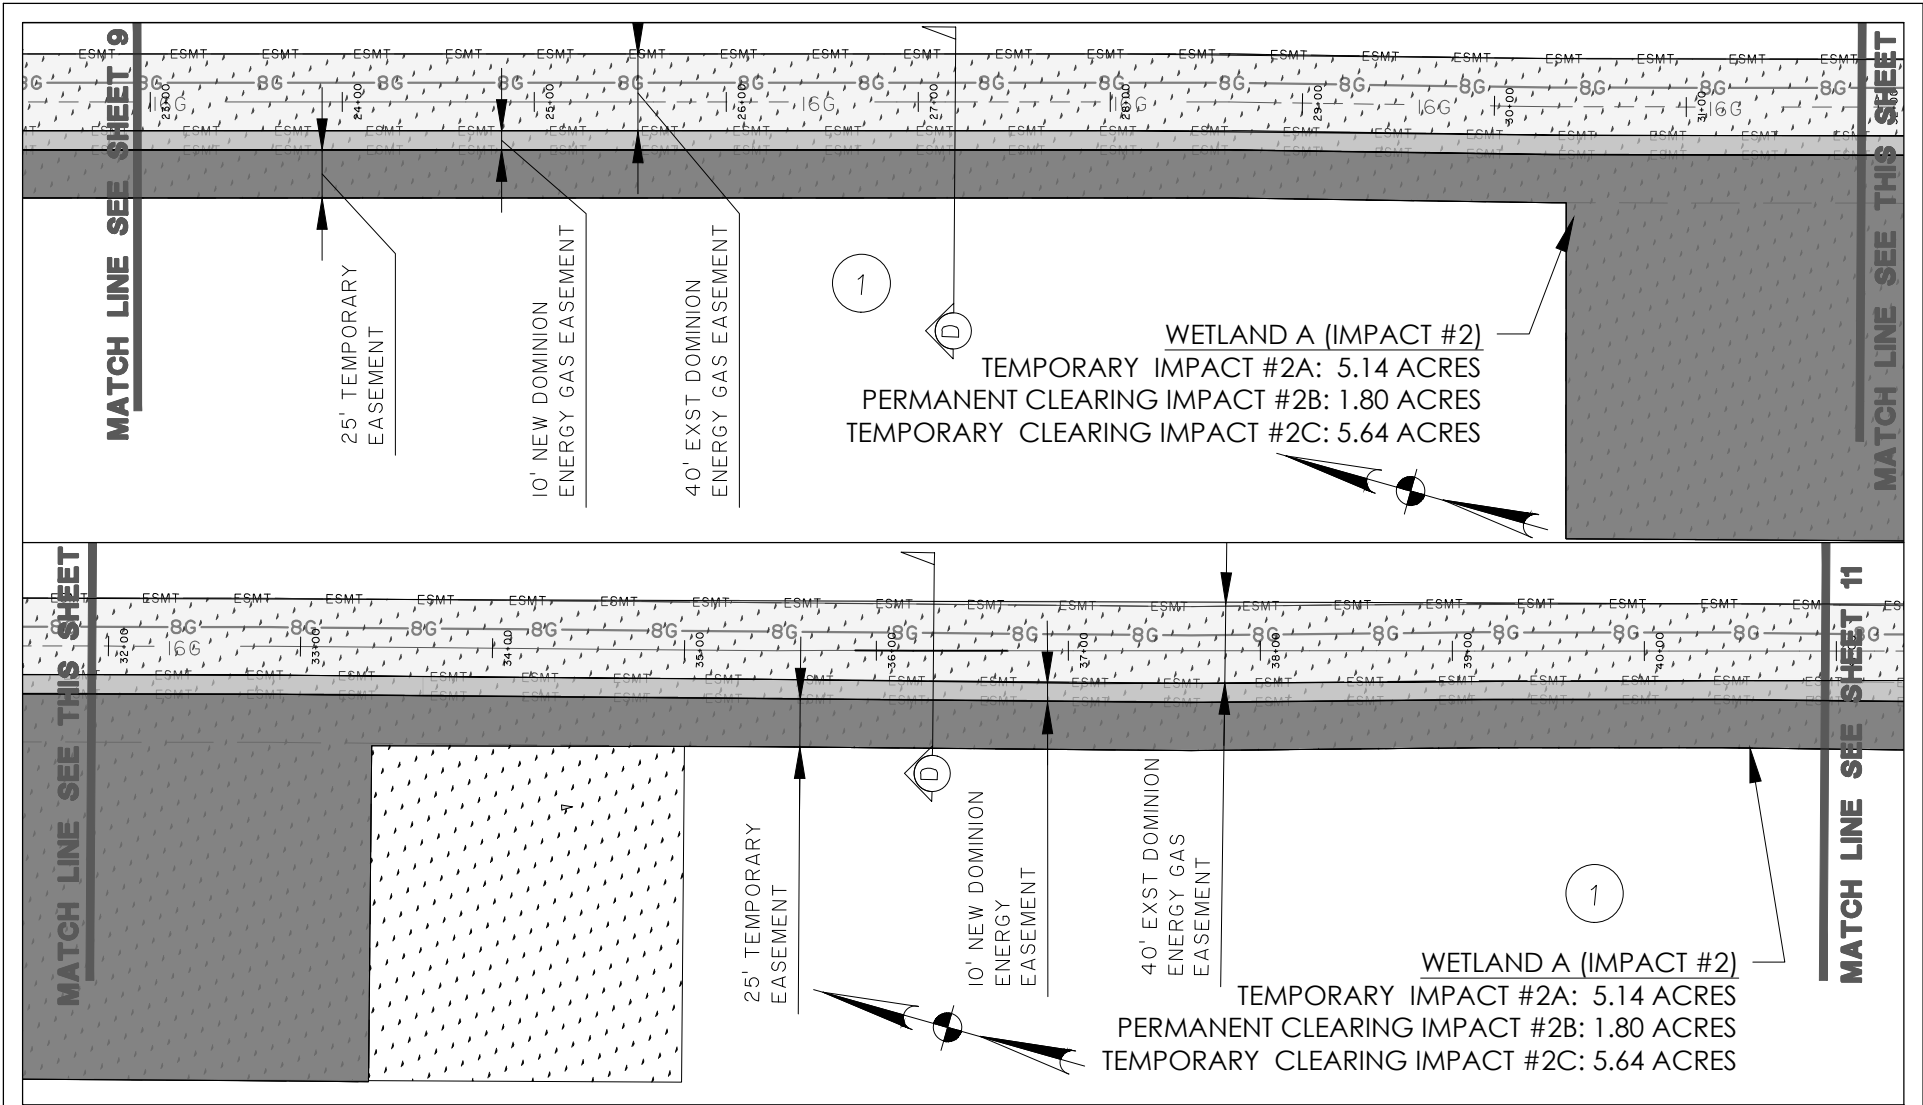
RIVER NECK TO KINGSBURG 16" GAS MAIN

WETLAND IMPACT AREAS 1 AND 2

CLIENT:
DOMINION ENERGY

LOCATION: FLORENCE COUNTY, SC
 DATE: 5/27/2020 DRAWN BY: DNF SHEET: 9
 JOB NUMBER: J-27886.0000 REVIEWED BY: JRS SCALE: 1" = 100'

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LEGEND

	TEMPORARY IMPACT
	PERMANENT CLEARING IMPACT
	TEMPORARY CLEARING IMPACT
	PROPOSED 16" GAS LINE (OPEN-CUT)
	PROPOSED 16" GAS LINE (HDD)
	WETLAND
	DOMINION ENERGY PERMANENT EASEMENT

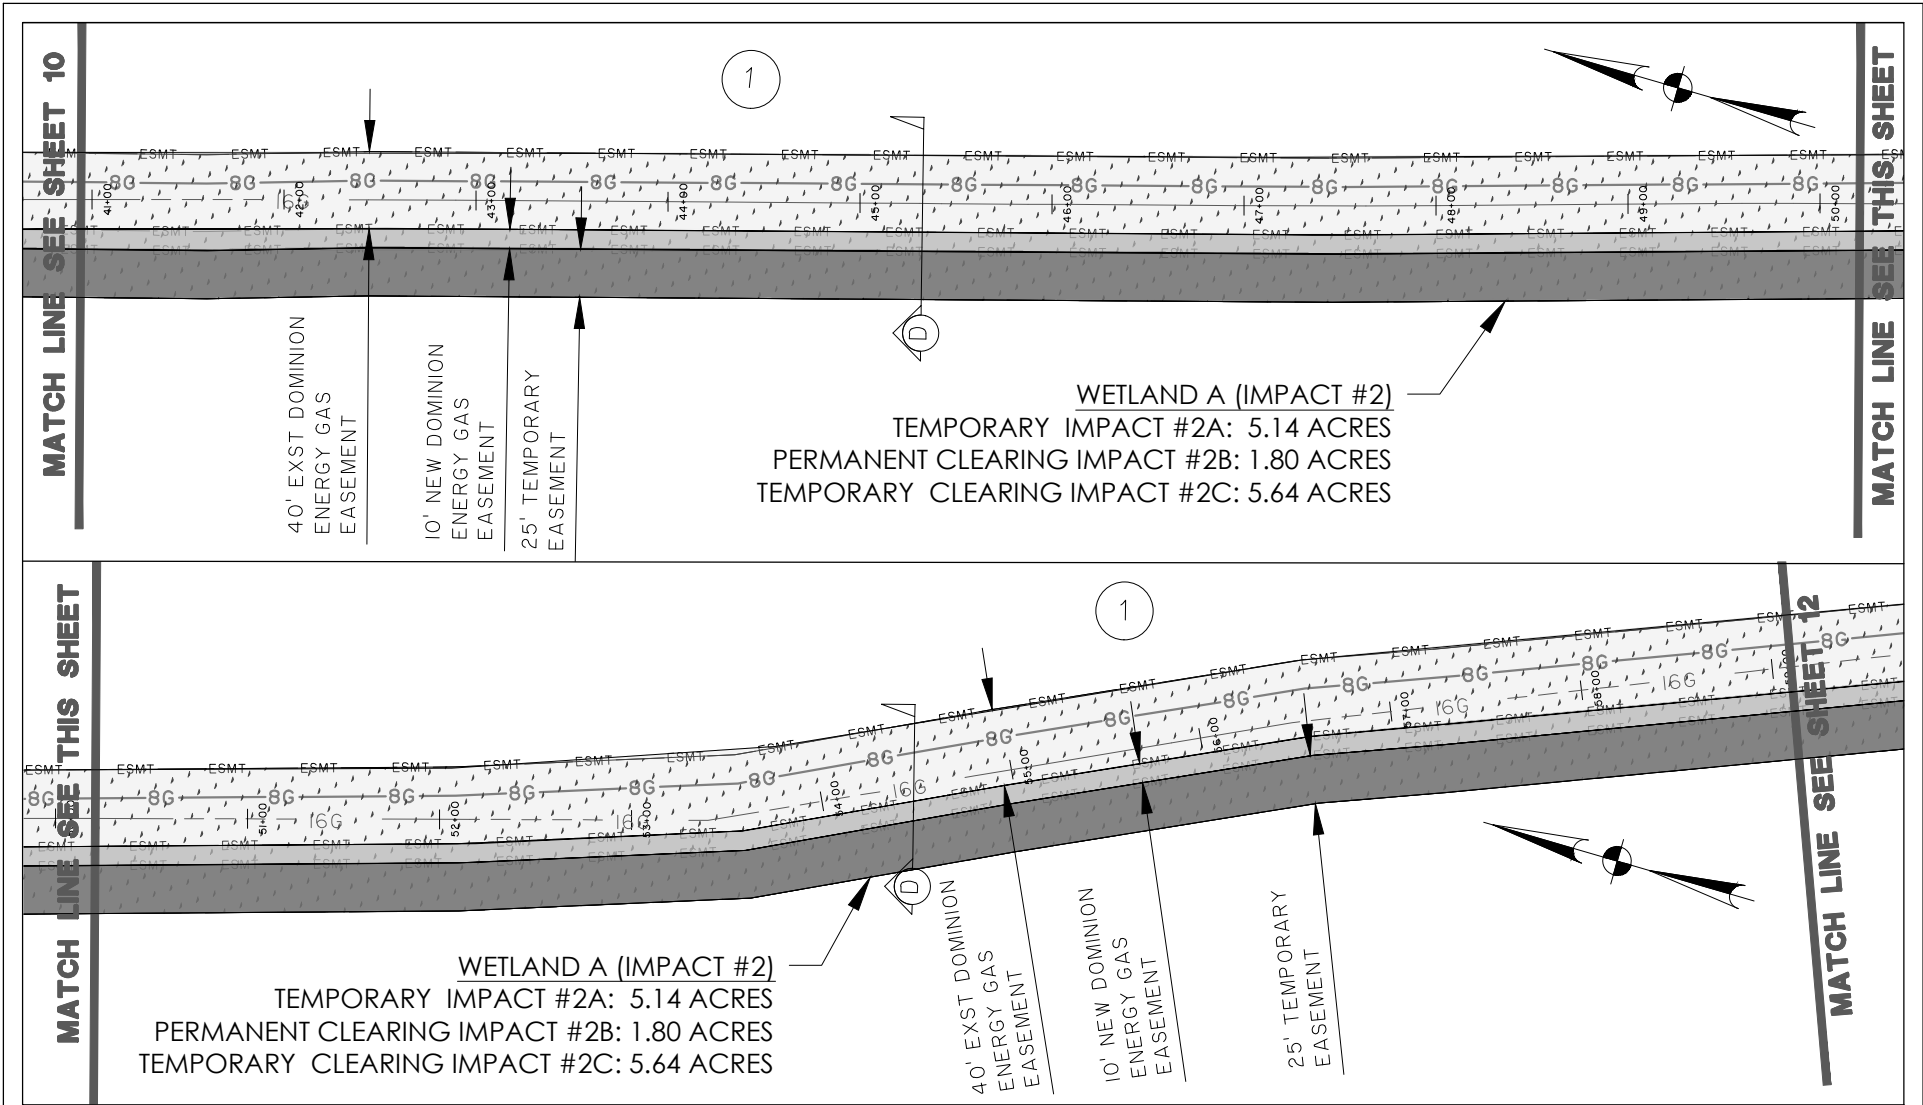
RIVER NECK TO KINGSBURG 16" GAS MAIN

WETLAND IMPACT AREAS 2

CLIENT:
DOMINION ENERGY

LOCATION: FLORENCE COUNTY, SC
 DATE: 5/27/2020 DRAWN BY: DNF SHEET: 10
 JOB NUMBER: J-27886.0000 REVIEWED BY: JRS SCALE: 1"=100'

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LEGEND

	TEMPORARY IMPACT
	PERMANENT CLEARING IMPACT
	TEMPORARY CLEARING IMPACT
	PROPOSED 16" GAS LINE (OPEN-CUT)
	PROPOSED 16" GAS LINE (HDD)
	WETLAND
	DOMINION ENERGY PERMANENT EASEMENT

RIVER NECK TO KINGSBURG 16" GAS MAIN

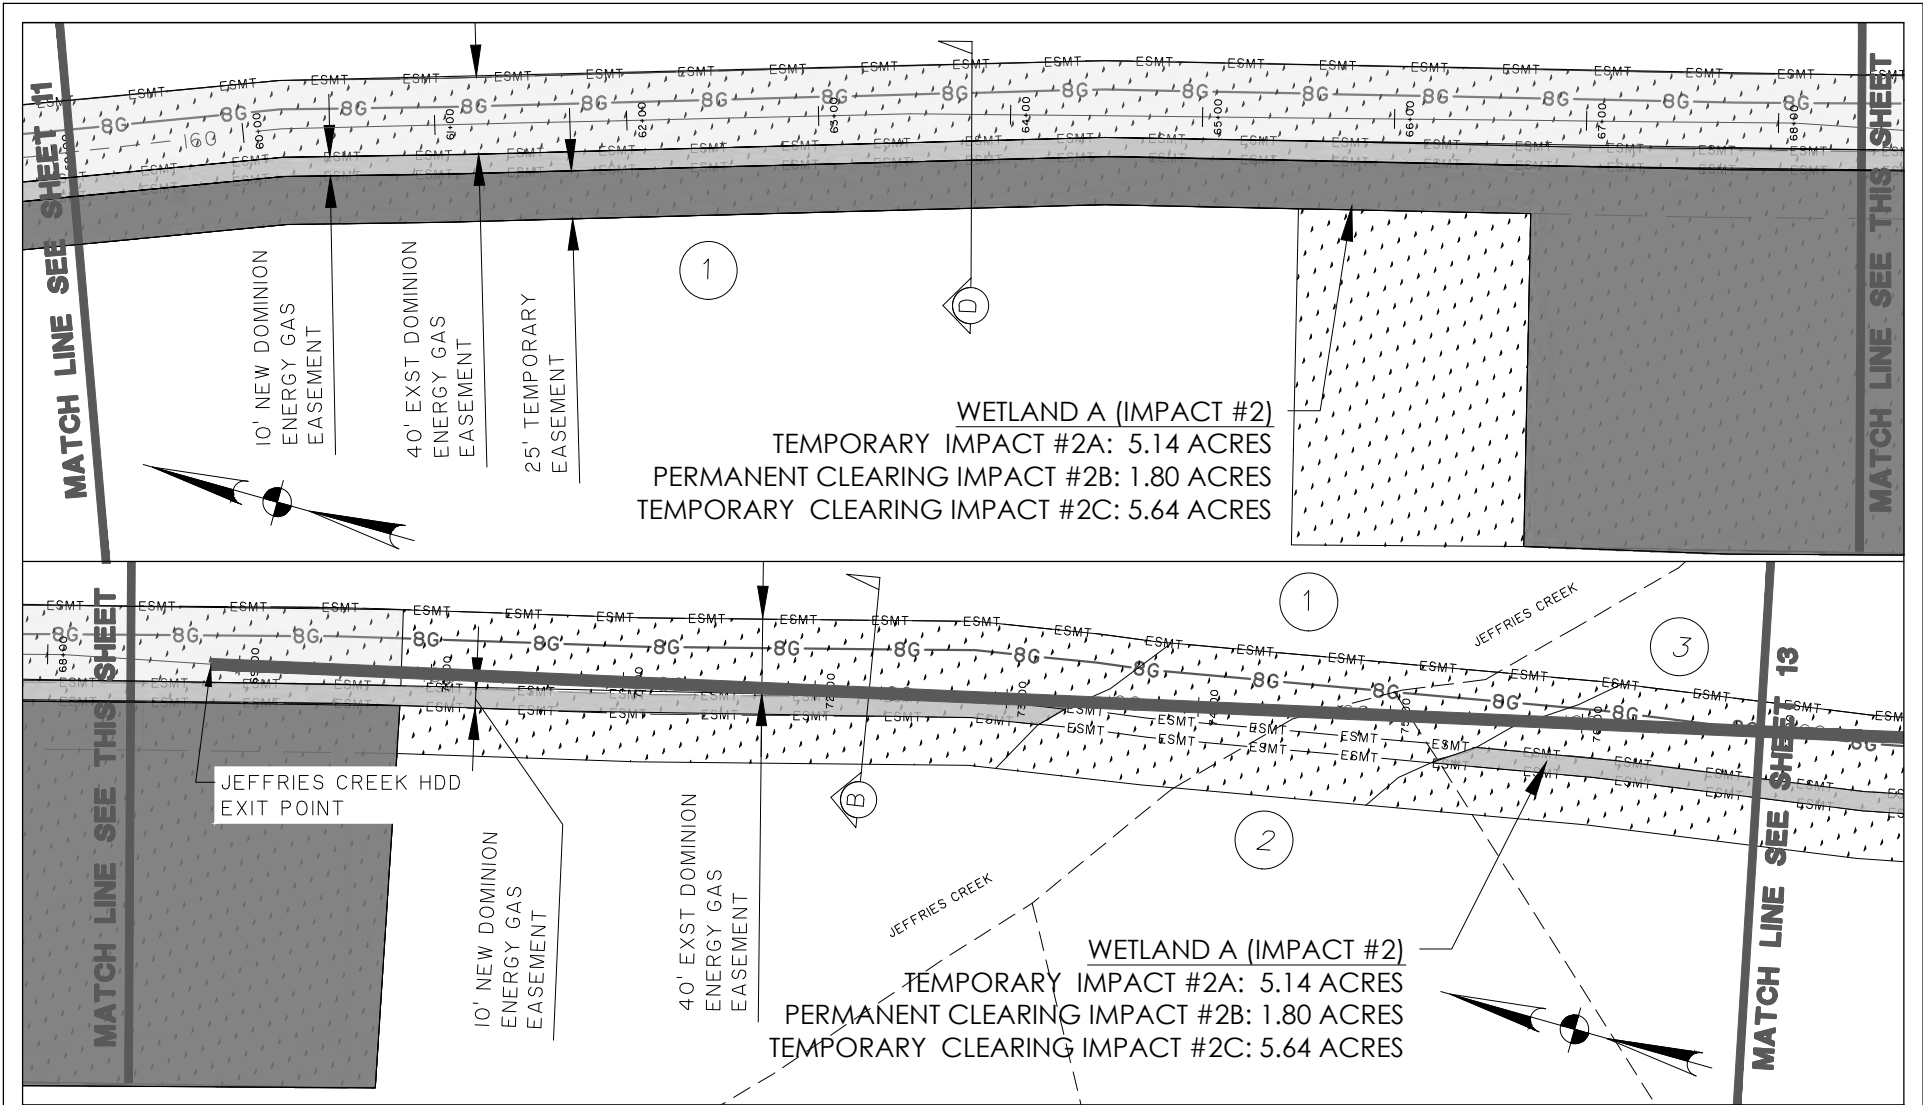
WETLAND IMPACT AREA 2

CLIENT:
DOMINION ENERGY

LOCATION: FLORENCE COUNTY, SC
 DATE: 5/27/2020 DRAWN BY: DNF SHEET: 11
 JOB NUMBER: J-27886.0000 REVIEWED BY: JRS SCALE: 1"=100'

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LEGEND

	TEMPORARY IMPACT
	PERMANENT CLEARING IMPACT
	TEMPORARY CLEARING IMPACT
	PROPOSED 16" GAS LINE (OPEN-CUT)
	PROPOSED 16" GAS LINE (HDD)
	WETLAND
	DOMINION ENERGY PERMANENT EASEMENT

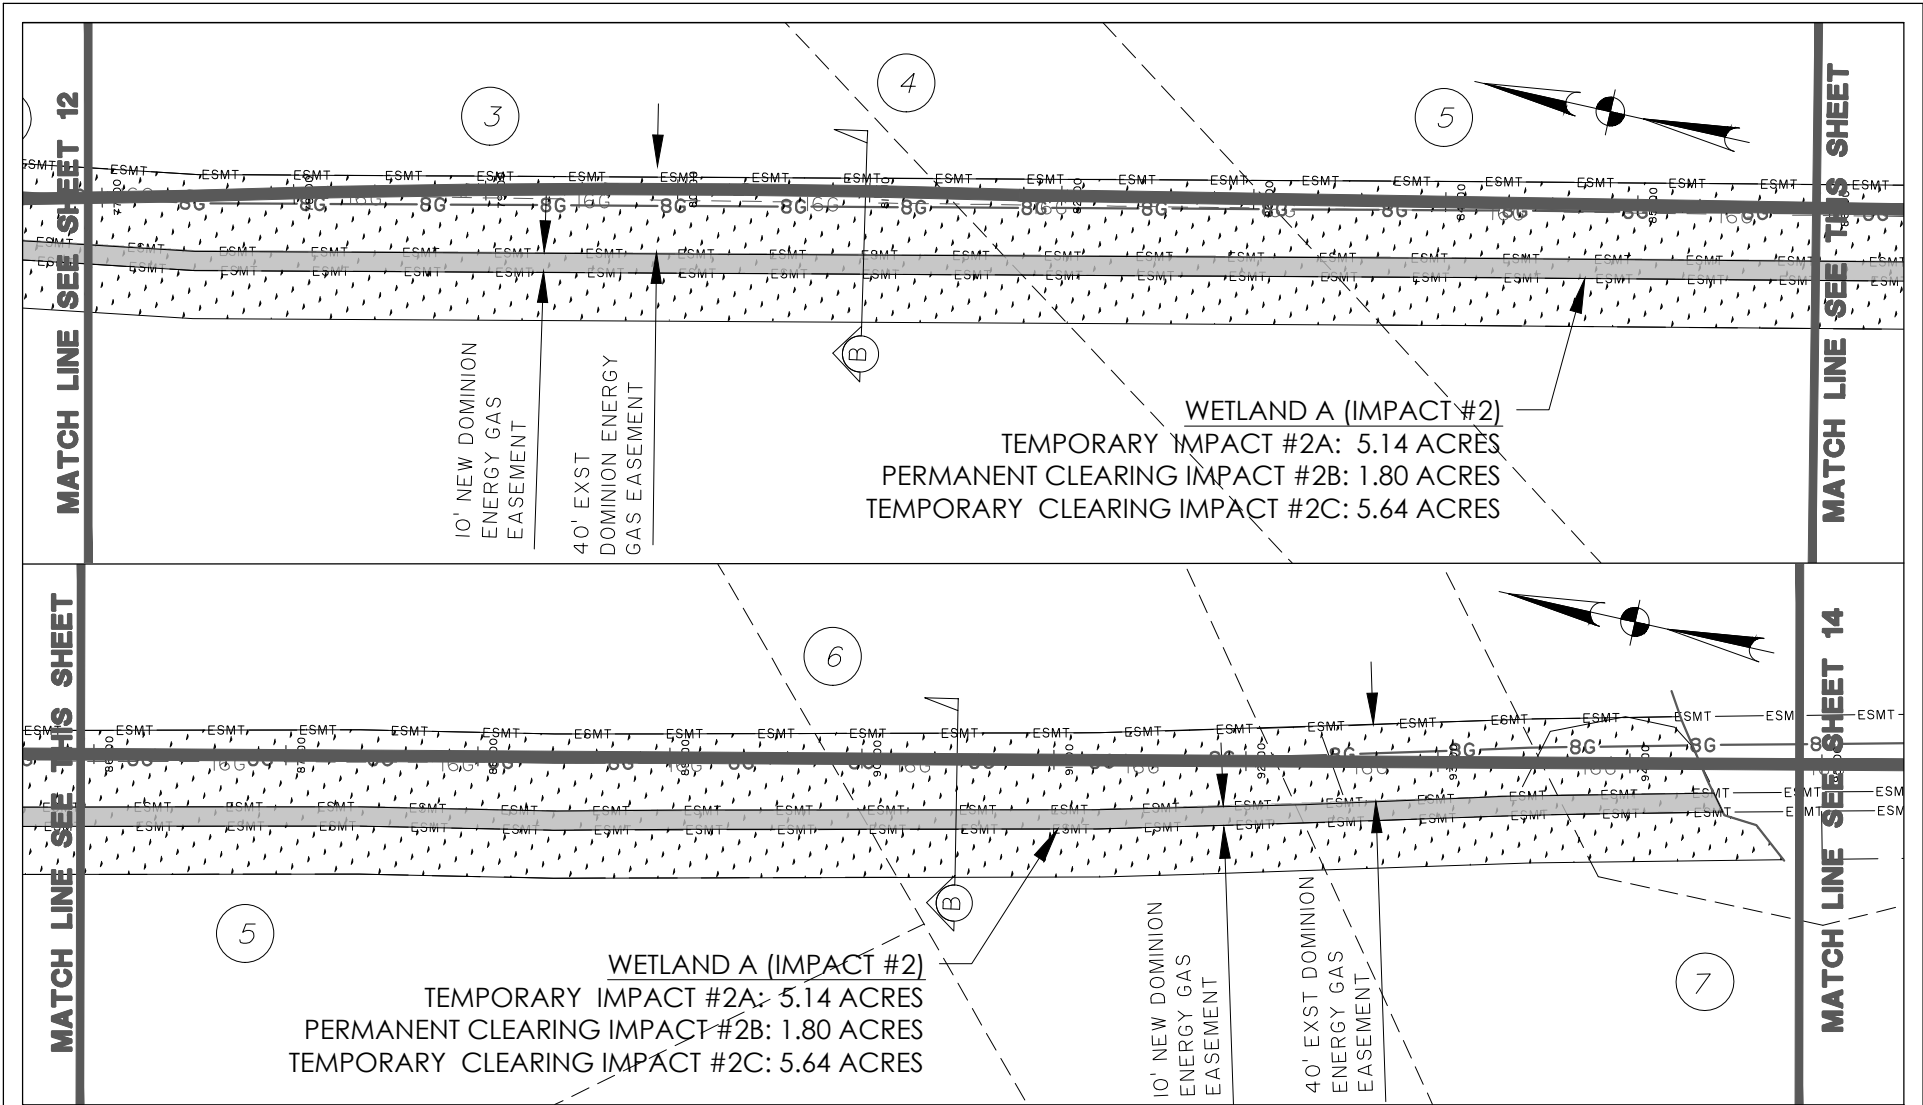
RIVER NECK TO KINGSBURG 16" GAS MAIN

WETLAND IMPACT AREA 2

CLIENT:
DOMINION ENERGY

LOCATION: FLORENCE COUNTY, SC
 DATE: 5/27/2020 DRAWN BY: DNF SHEET: 12
 JOB NUMBER: J-27886.0000 REVIEWED BY: JRS SCALE: 1"=100'

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LEGEND

	TEMPORARY IMPACT
	PERMANENT CLEARING IMPACT
	TEMPORARY CLEARING IMPACT
	PROPOSED 16" GAS LINE (OPEN-CUT)
	PROPOSED 16" GAS LINE (HDD)
	WETLAND
	DOMINION ENERGY PERMANENT EASEMENT

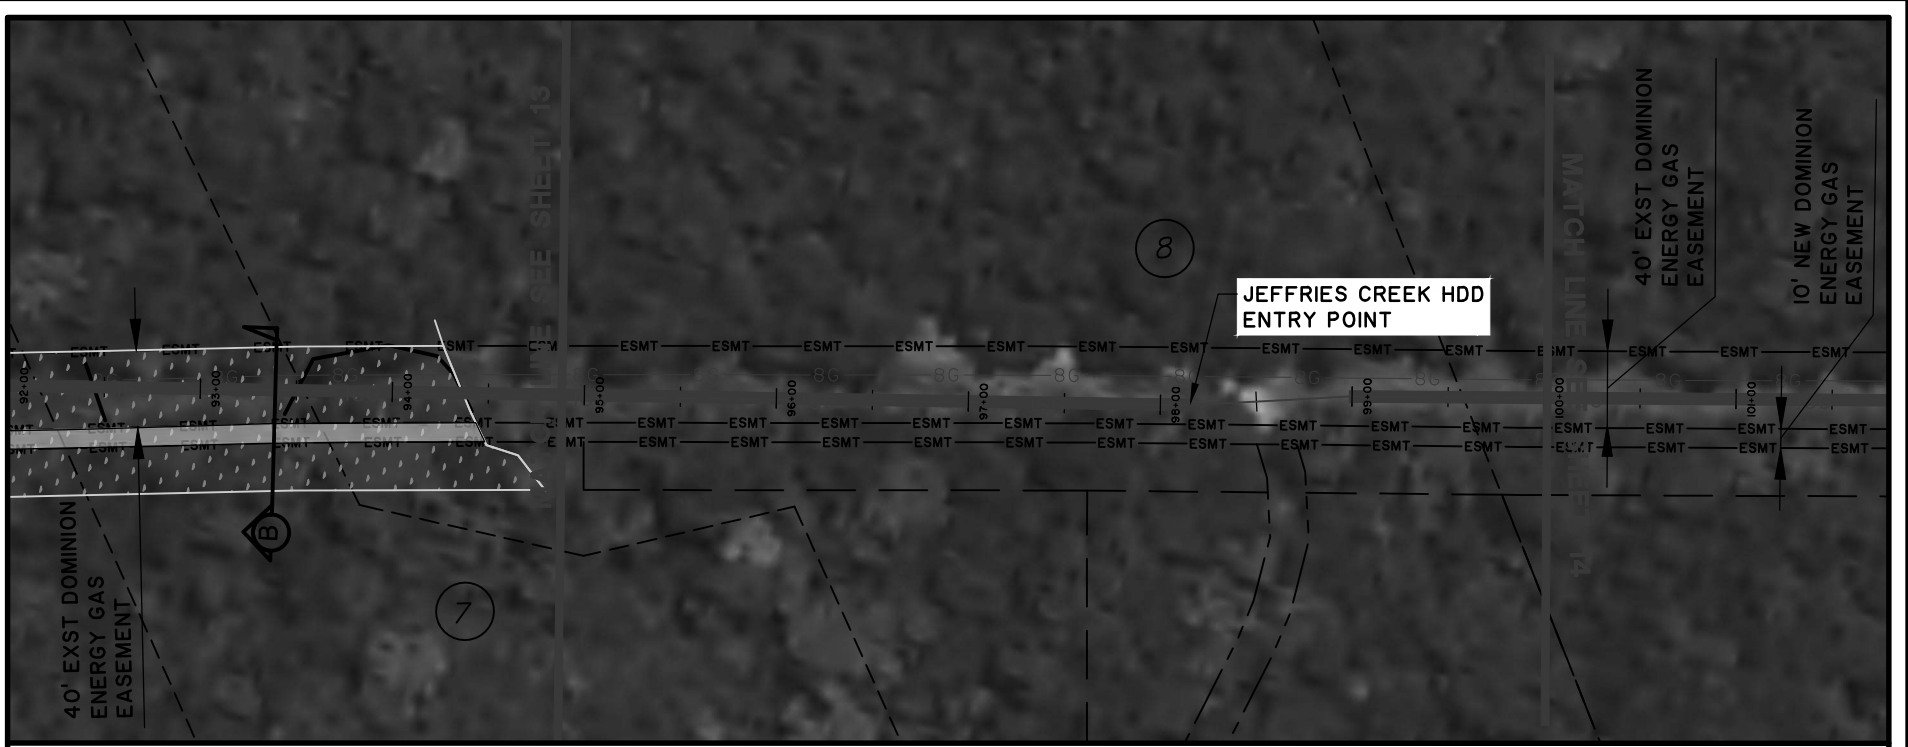
RIVER NECK TO KINGSBURG 16" GAS MAIN

WETLAND IMPACT AREA 2

CLIENT:
DOMINION ENERGY

LOCATION: FLORENCE COUNTY, SC
 DATE: 5/27/2020 DRAWN BY: DNF SHEET: 13
 JOB NUMBER: J-27886.0000 REVIEWED BY: JRS SCALE: 1"=100'

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LEGEND

	TEMPORARY IMPACT
	PERMANENT CLEARING IMPACT
	TEMPORARY CLEARING IMPACT
	PROPOSED 16" GAS LINE (OPEN-CUT)
	PROPOSED 16" GAS LINE (HDD)
	WETLAND
	DOMINION ENERGY PERMANENT EASEMENT

RIVER NECK TO KINGSBURG 16" GAS MAIN

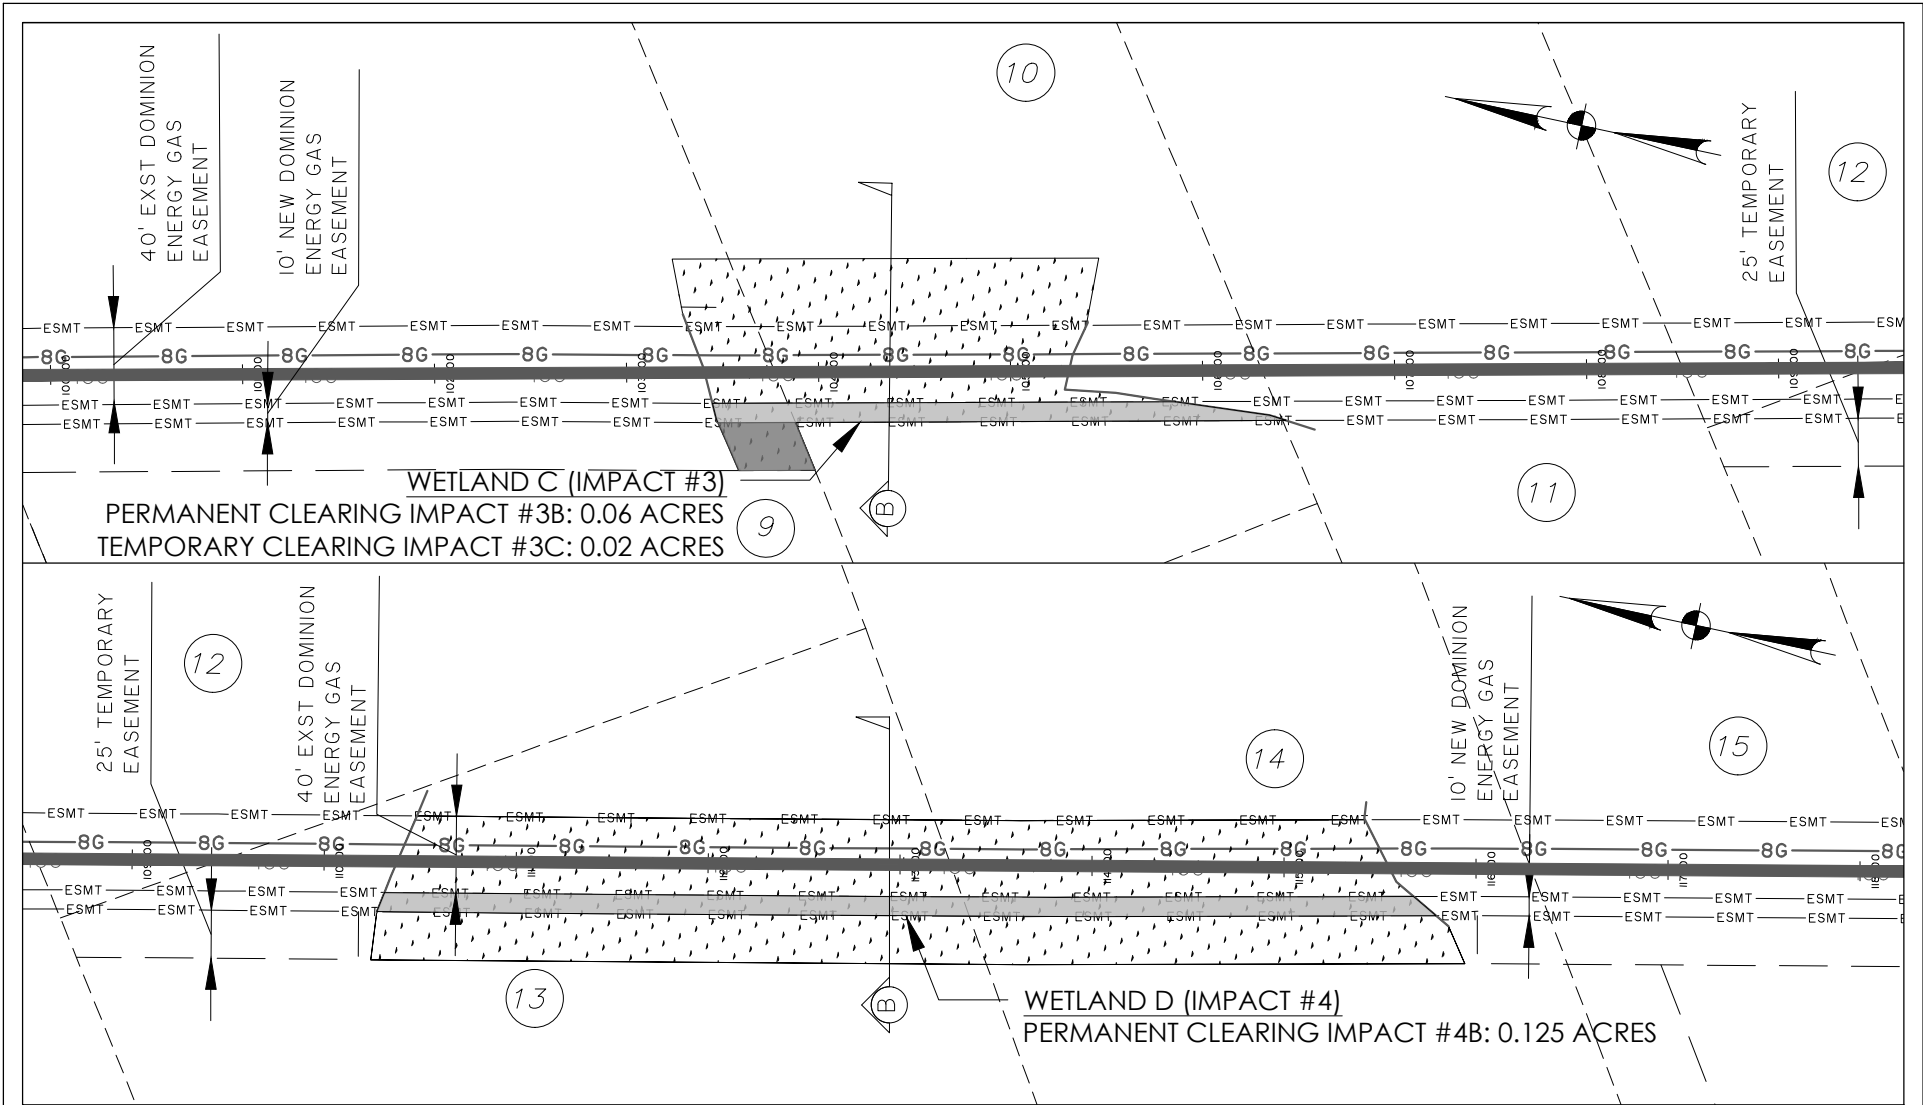
WETLAND AREA 2 - JEFFIRES CREEK ENTRY POINT

CLIENT:
DOMINION ENERGY

LOCATION: FLORENCE COUNTY, SC
 DATE: 5/18/2021 DRAWN BY: DNF SHEET: 13A
 JOB NUMBER: J-27886.0000 REVIEWED BY: JRS SCALE: 1"=100'



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WETLAND C (IMPACT #3)
 PERMANENT CLEARING IMPACT #3B: 0.06 ACRES
 TEMPORARY CLEARING IMPACT #3C: 0.02 ACRES

WETLAND D (IMPACT #4)
 PERMANENT CLEARING IMPACT #4B: 0.125 ACRES

LEGEND

	TEMPORARY IMPACT
	PERMANENT CLEARING IMPACT
	TEMPORARY CLEARING IMPACT
	PROPOSED 16" GAS LINE (OPEN-CUT)
	PROPOSED 16" GAS LINE (HDD)
	WETLAND
	DOMINION ENERGY PERMANENT EASEMENT

RIVER NECK TO KINGSBURG 16" GAS MAIN

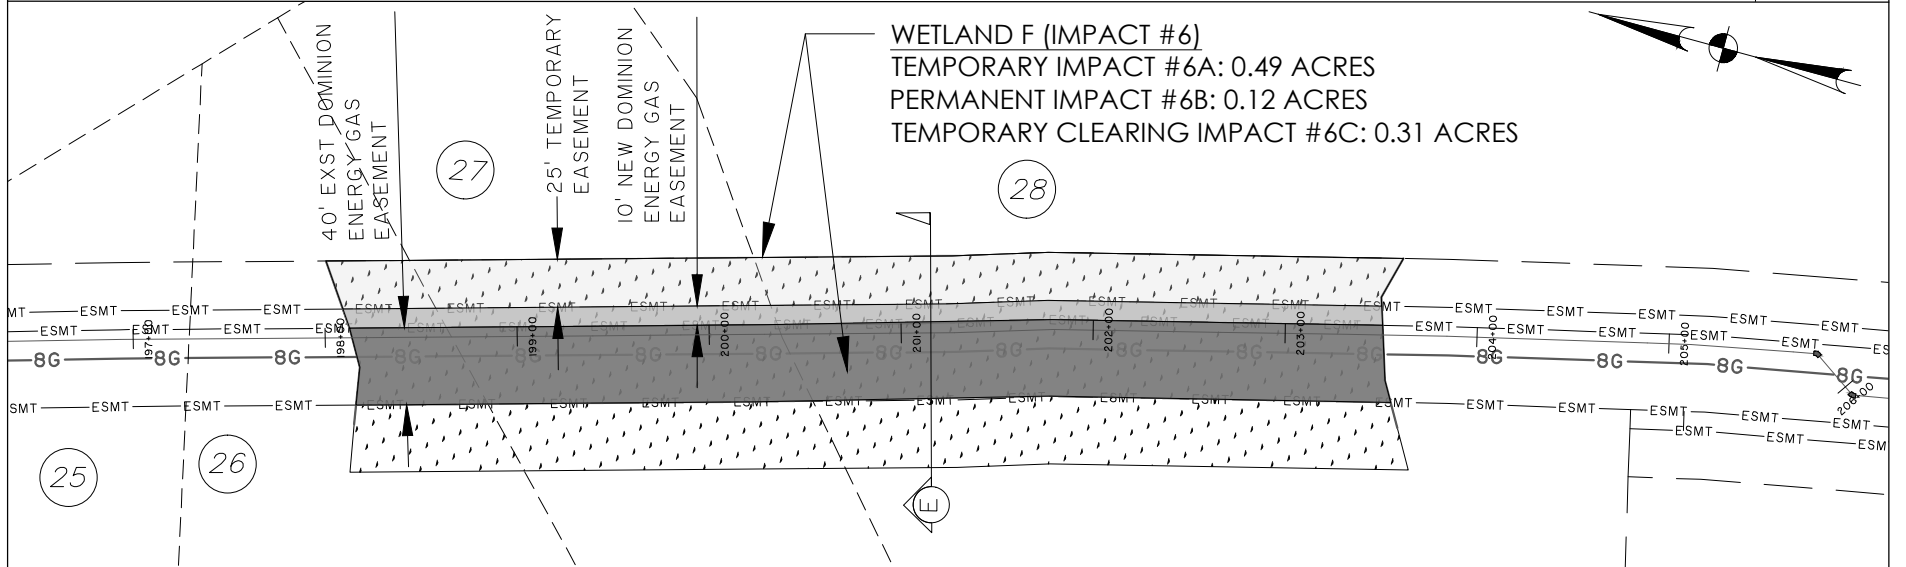
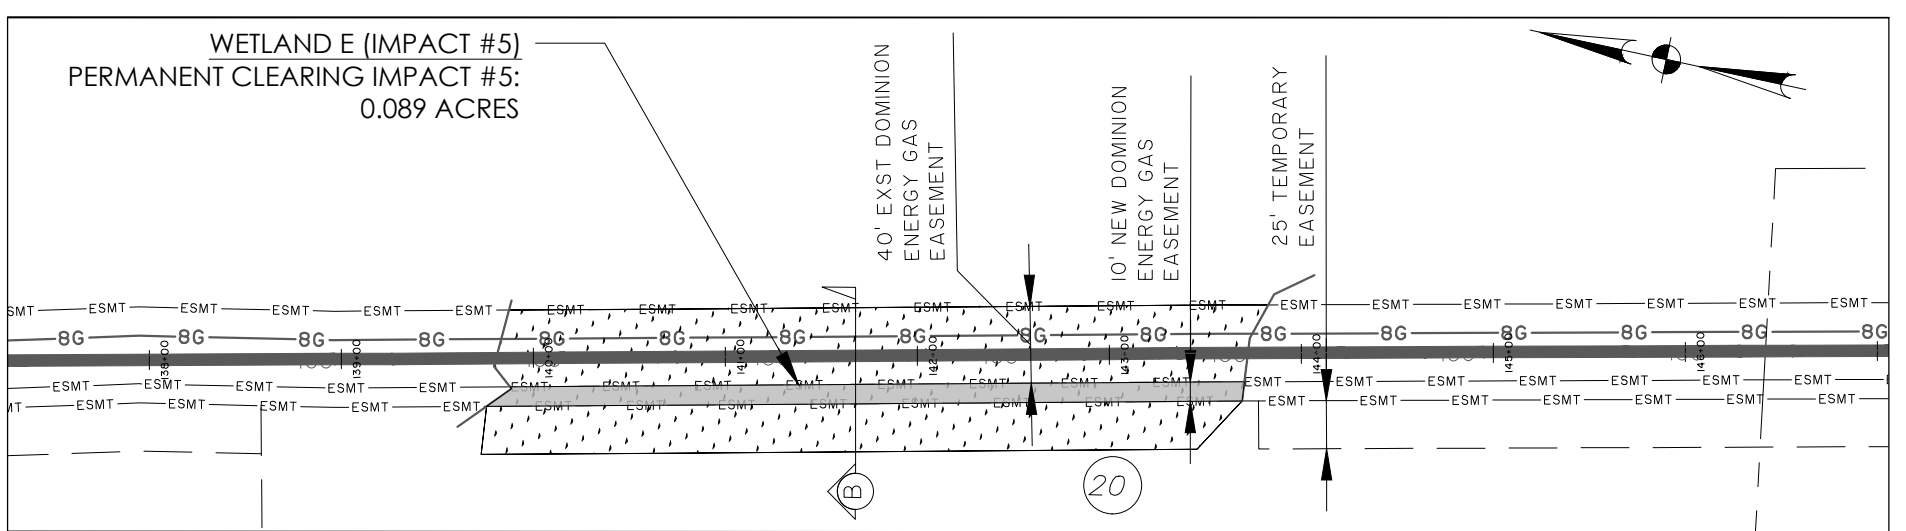
WETLAND IMPACT AREAS 3 AND 4

CLIENT:
DOMINION ENERGY







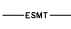
LOCATION: FLORENCE COUNTY, SC
 DATE: 5/27/2020 DRAWN BY: DNF SHEET: 14
 JOB NUMBER: J-27886.0000 REVIEWED BY: JRS SCALE: 1"=100'

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LEGEND

	TEMPORARY IMPACT
	PERMANENT CLEARING IMPACT
	TEMPORARY CLEARING IMPACT
	PROPOSED 16" GAS LINE (OPEN-CUT)
	PROPOSED 16" GAS LINE (HDD)
	WETLAND
	DOMINION ENERGY PERMANENT EASEMENT

RIVER NECK TO KINGSBURG 16" GAS MAIN

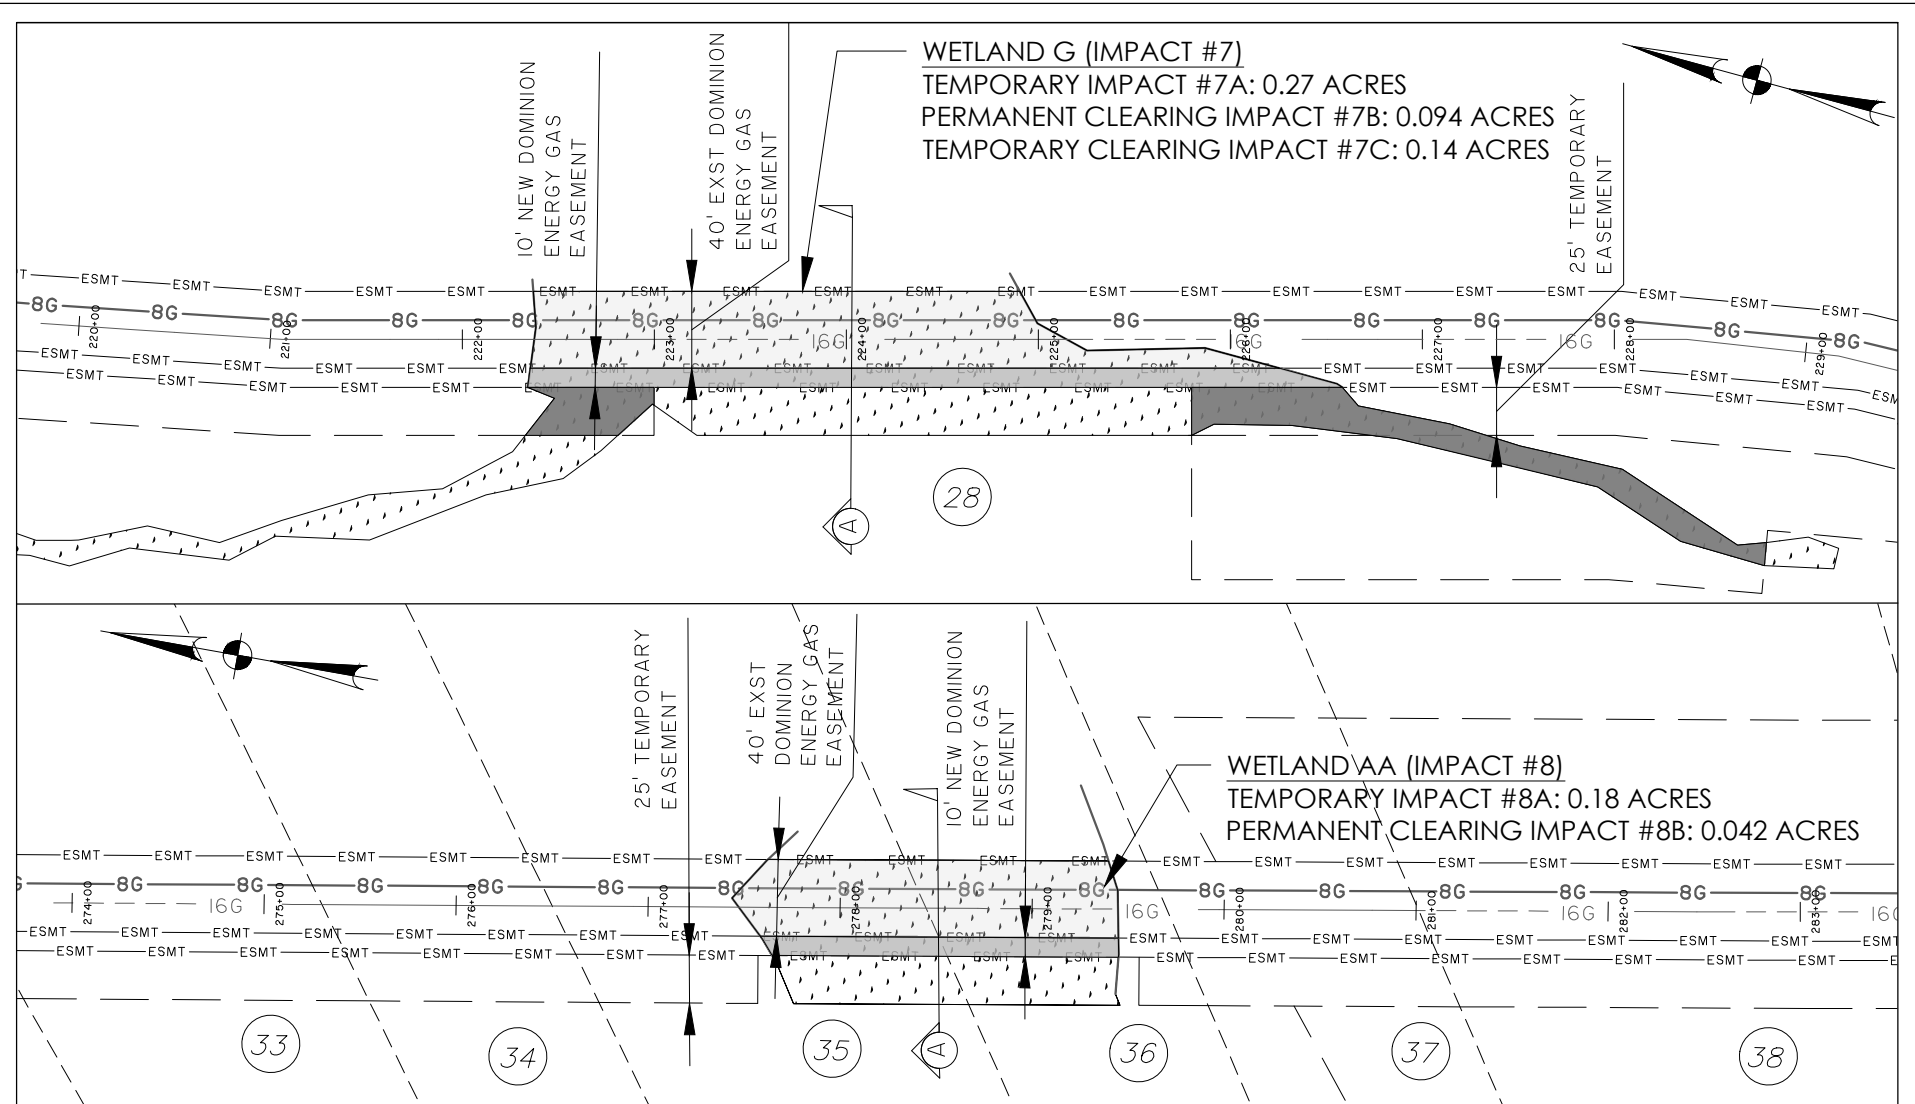
WETLAND IMPACT AREAS 5 AND 6

CLIENT:
DOMINION ENERGY

LOCATION: FLORENCE COUNTY, SC
 DATE: 5/27/2020 DRAWN BY: DNF SHEET: 15
 JOB NUMBER: J-27886.0000 REVIEWED BY: JRS SCALE: 1"=100'



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LEGEND

	TEMPORARY IMPACT
	PERMANENT CLEARING IMPACT
	TEMPORARY CLEARING IMPACT
	PROPOSED 16" GAS LINE (OPEN-CUT)
	PROPOSED 16" GAS LINE (HDD)
	WETLAND
	DOMINION ENERGY PERMANENT EASEMENT

RIVER NECK TO KINGSBURG 16" GAS MAIN

WETLAND IMPACT AREAS 7 AND 8

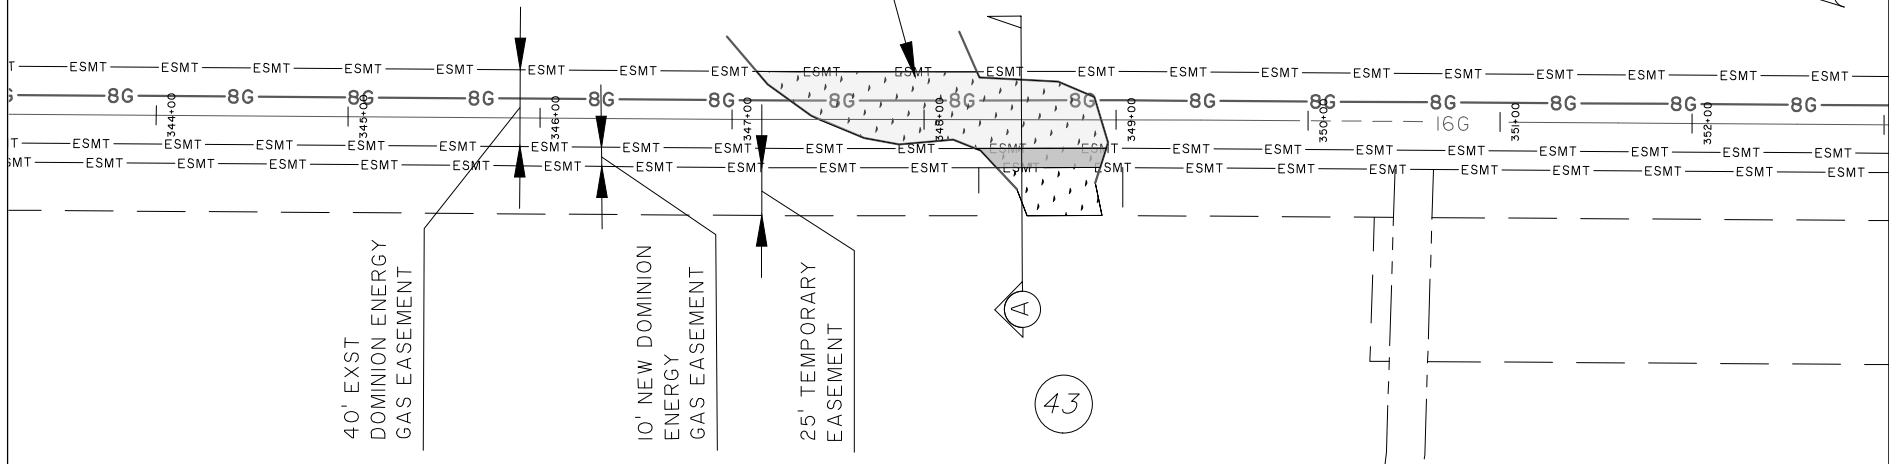
CLIENT:
DOMINION ENERGY

LOCATION: FLORENCE COUNTY, SC
 DATE: 5/27/2020 DRAWN BY: DNF SHEET: 16
 JOB NUMBER: J-27886.0000 REVIEWED BY: JRS SCALE: 1"=100'

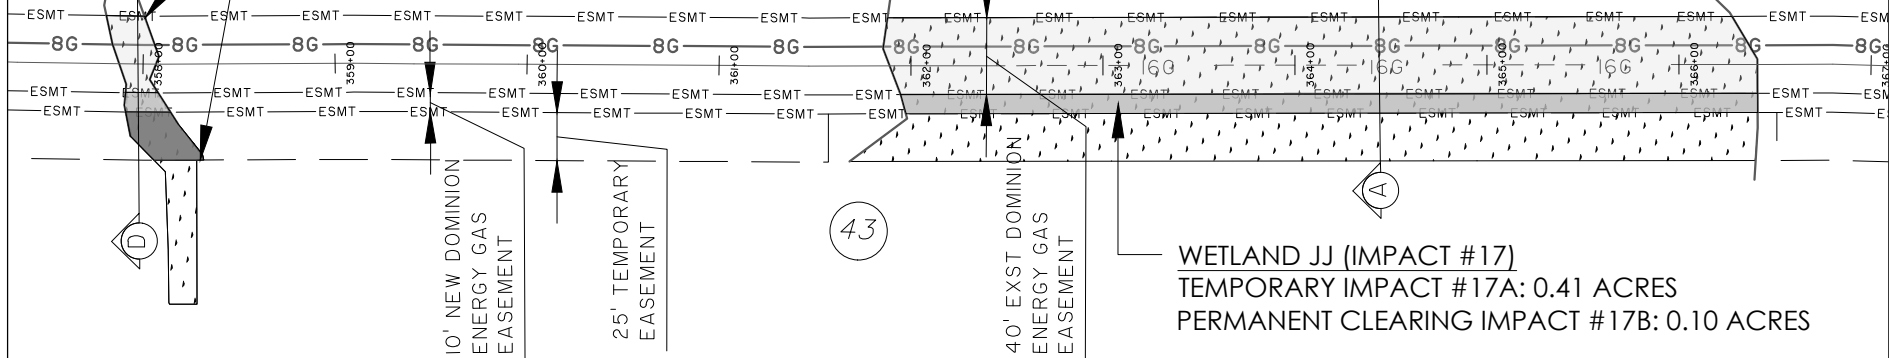
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WETLAND HH (IMPACT #15)
 TEMPORARY IMPACT #15A: 0.13 ACRES
 PERMANENT CLEARING IMPACT #15B: 0.014 ACRES

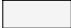
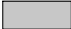







WETLAND II (IMPACT #16)
 TEMPORARY IMPACT #16A: 0.017 ACRES
 PERMANENT CLEARING IMPACT #16B: 0.005 ACRES
 TEMPORARY CLEARING IMPACT #16C: 0.016 ACRES



WETLAND JJ (IMPACT #17)
 TEMPORARY IMPACT #17A: 0.41 ACRES
 PERMANENT CLEARING IMPACT #17B: 0.10 ACRES

LEGEND

-  TEMPORARY IMPACT
-  PERMANENT CLEARING IMPACT
-  TEMPORARY CLEARING IMPACT
-  PROPOSED 16" GAS LINE (OPEN-CUT)
-  PROPOSED 16" GAS LINE (HDD)
-  WETLAND
-  DOMINION ENERGY PERMANENT EASEMENT

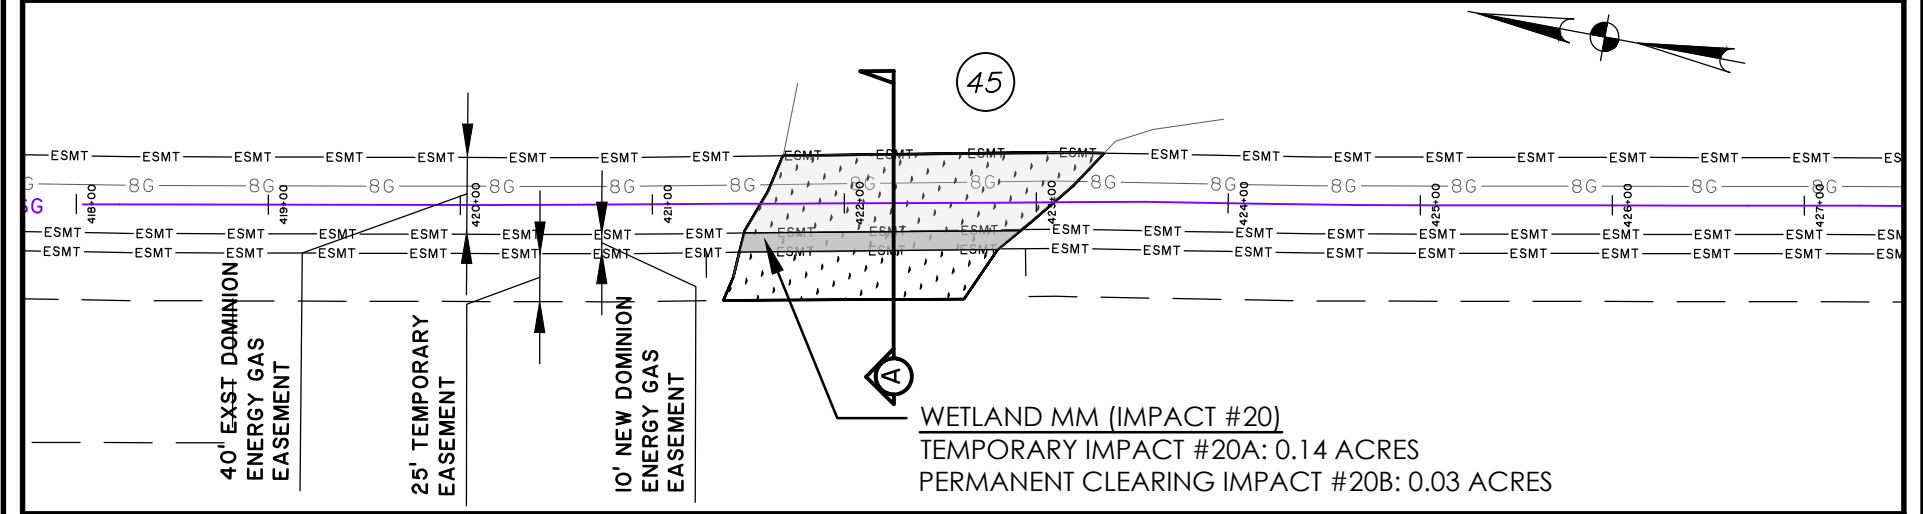
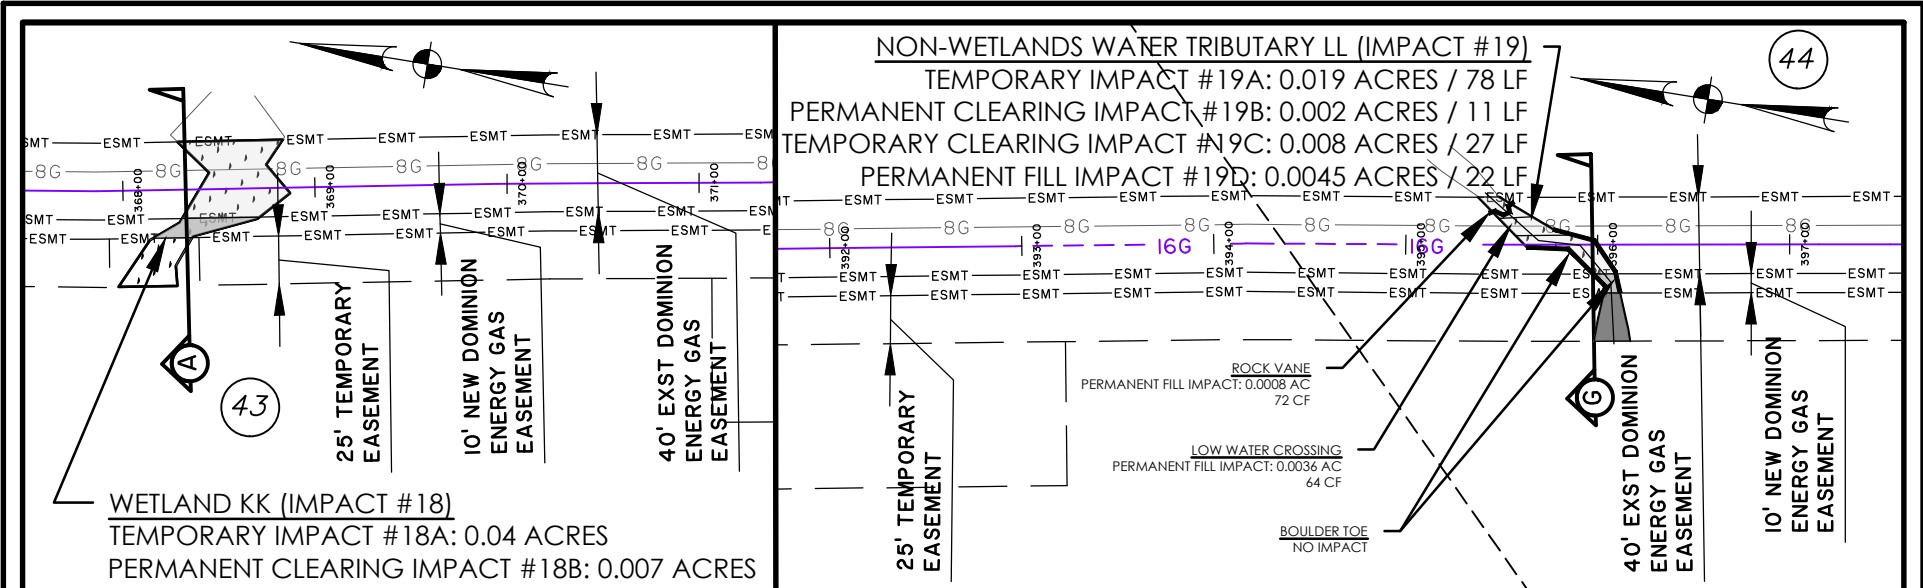
RIVER NECK TO KINGSBURG 16" GAS MAIN

WETLAND IMPACT AREAS 15, 16 AND 17

CLIENT:
DOMINION ENERGY
 LOCATION: FLORENCE COUNTY, SC
 DATE: 5/27/2020 DRAWN BY: DNF SHEET: 19
 JOB NUMBER: J-27886.0000 REVIEWED BY: JRS SCALE: 1"=100'



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LEGEND

	TEMPORARY IMPACT
	PERMANENT CLEARING IMPACT
	TEMPORARY CLEARING IMPACT
	PERMANENT FILL IMPACT
	WETLAND
	DOMINION ENERGY PERMANENT EASEMENT

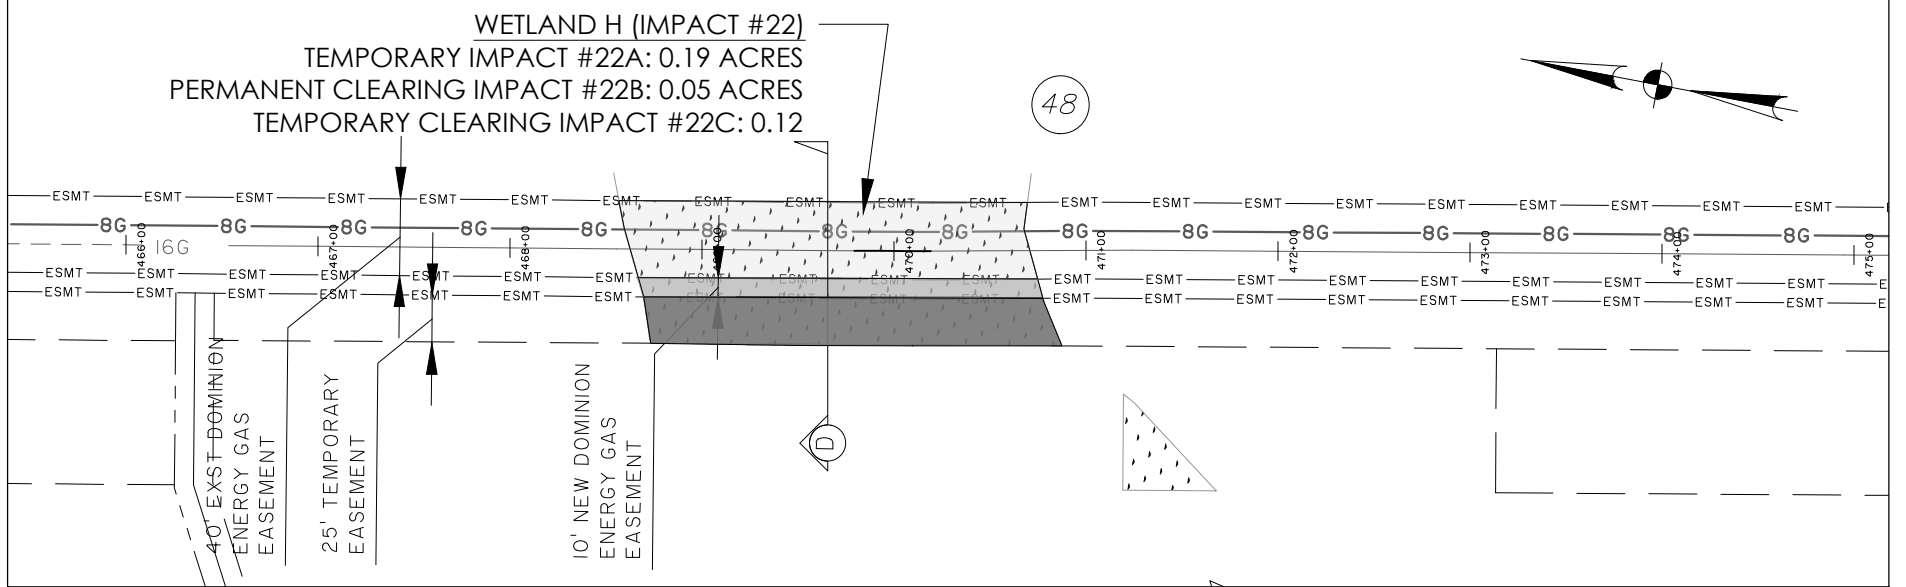
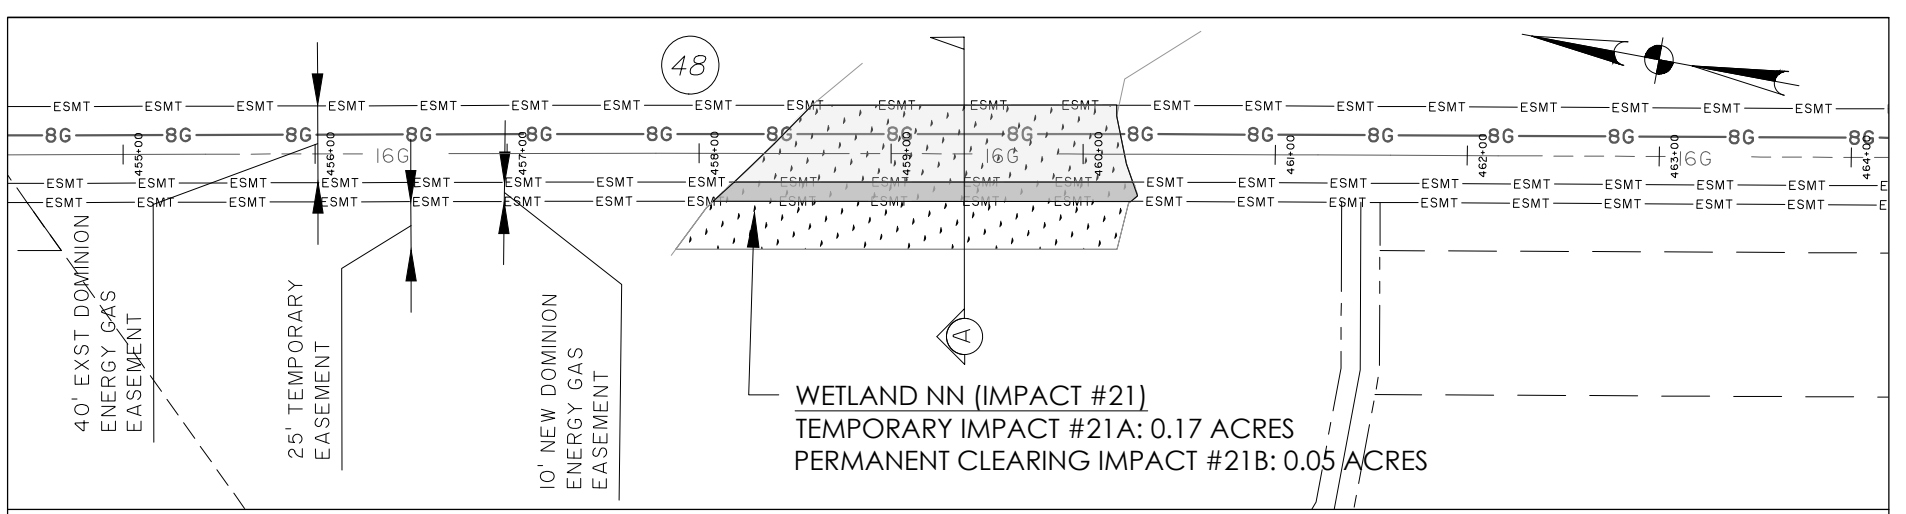
RIVER NECK TO KINGSBURG 16" GAS MAIN

WETLAND IMPACT AREAS 18, 19 AND 20

CLIENT:
DOMINION ENERGY

LOCATION: FLORENCE COUNTY, SC
 DATE: 5/27/2020 DRAWN BY: DNF SHEET: 20
 JOB NUMBER: J-27886.0000 REVIEWED BY: JRS SCALE: 1"=100'

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LEGEND

	TEMPORARY IMPACT
	PERMANENT CLEARING IMPACT
	TEMPORARY CLEARING IMPACT
	PROPOSED 16" GAS LINE (OPEN-CUT)
	PROPOSED 16" GAS LINE (HDD)
	WETLAND
	DOMINION ENERGY PERMANENT EASEMENT

RIVER NECK TO KINGSBURG 16" GAS MAIN

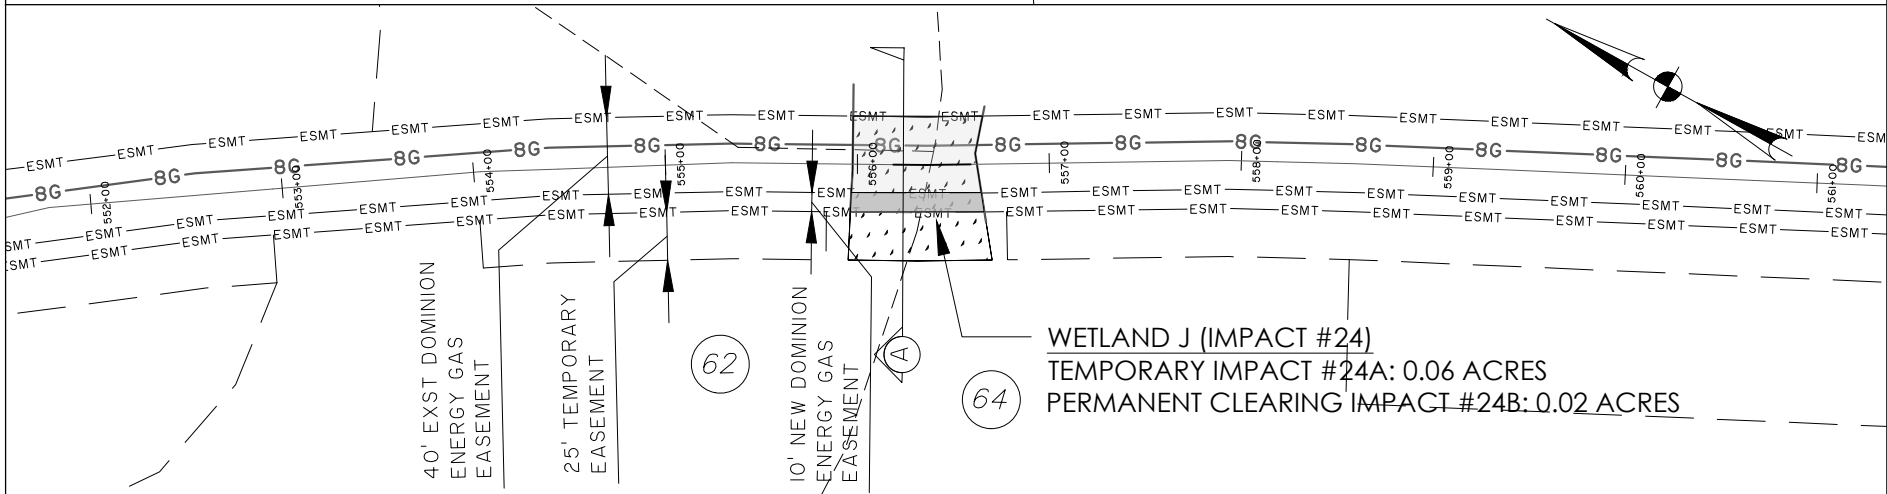
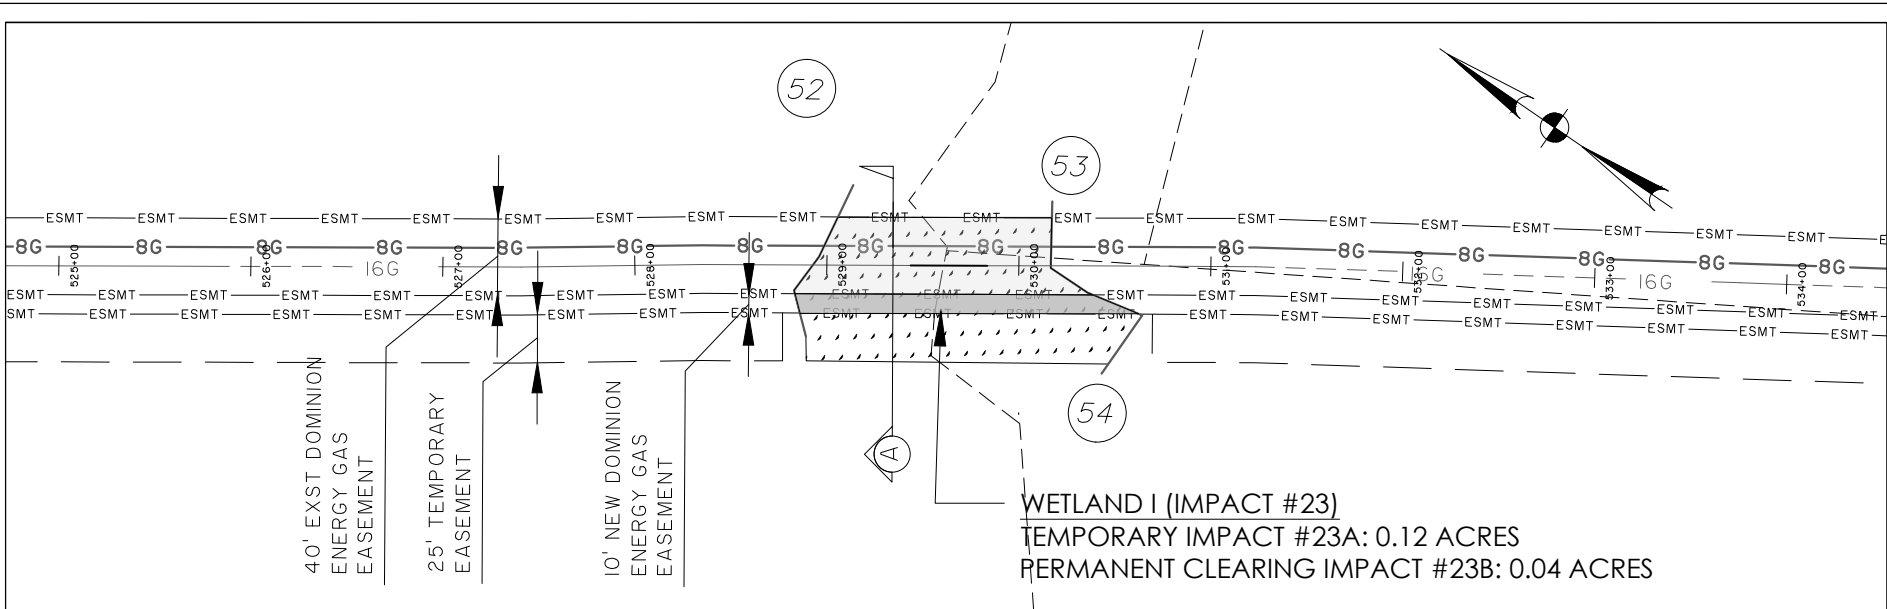
WETLAND IMPACT AREAS 21 AND 22

CLIENT:
DOMINION ENERGY

LOCATION: FLORENCE COUNTY, SC
 DATE: 5/27/2020 DRAWN BY: DNF SHEET: 21
 JOB NUMBER: J-27886.0000 REVIEWED BY: JRS SCALE: 1"=100'

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LEGEND

	TEMPORARY IMPACT
	PERMANENT CLEARING IMPACT
	TEMPORARY CLEARING IMPACT
	PROPOSED 16" GAS LINE (OPEN-CUT)
	PROPOSED 16" GAS LINE (HDD)
	WETLAND
	DOMINION ENERGY PERMANENT EASEMENT

RIVER NECK TO KINGSBURG 16" GAS MAIN

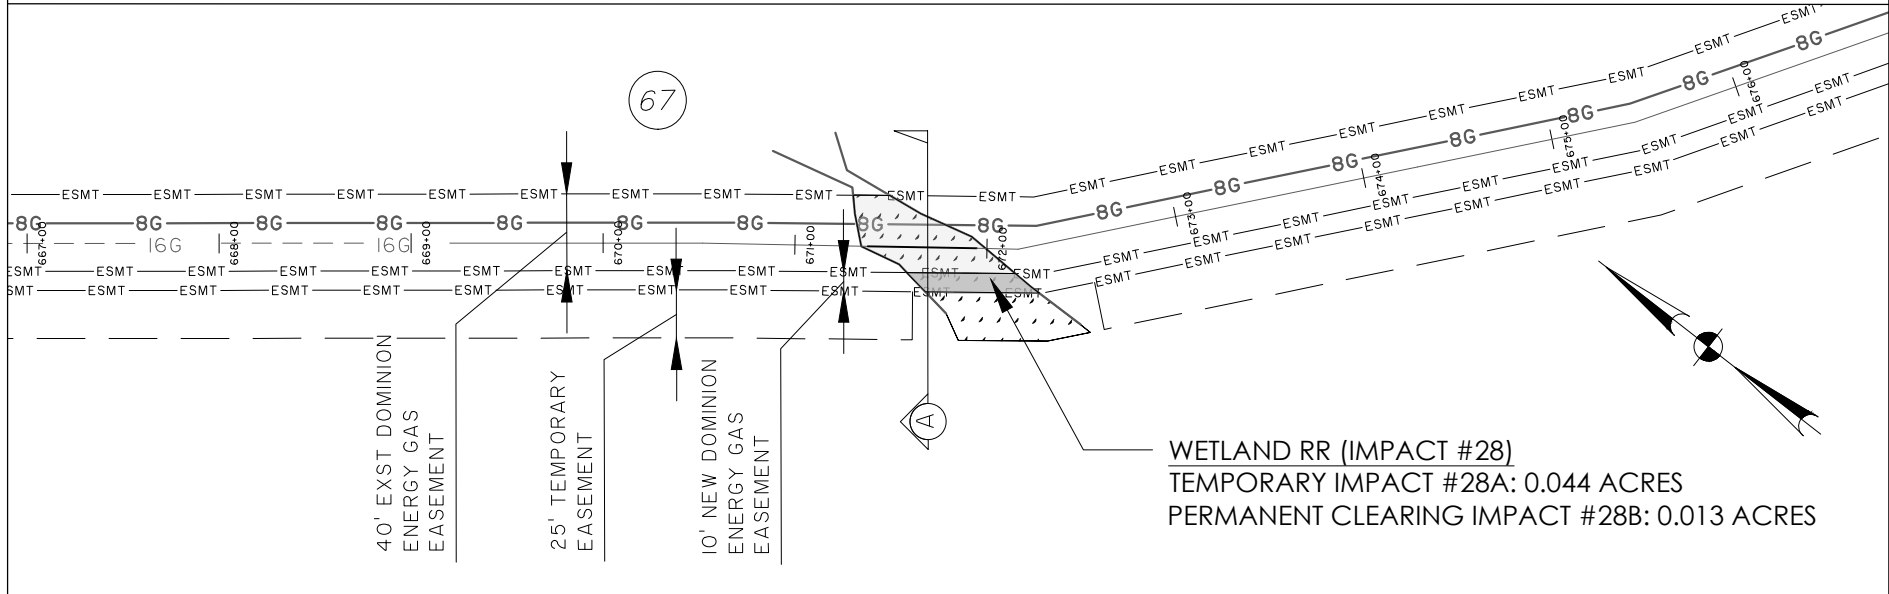
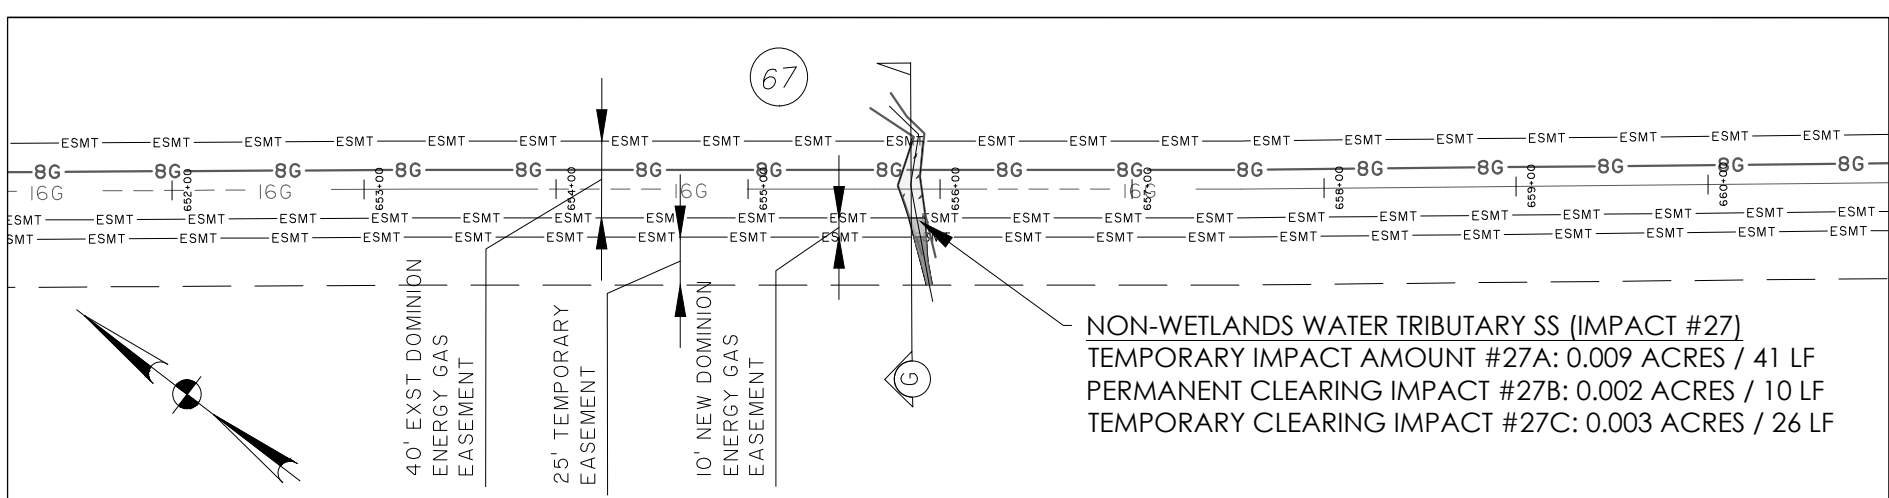
WETLAND IMPACT AREAS 23 AND 24

CLIENT:
DOMINION ENERGY

LOCATION: FLORENCE COUNTY, SC
 DATE: 5/27/2020 DRAWN BY: DNF SHEET: 22
 JOB NUMBER: J-27886.0000 REVIEWED BY: JRS SCALE: 1"=100'

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LEGEND

	TEMPORARY IMPACT
	PERMANENT CLEARING IMPACT
	TEMPORARY CLEARING IMPACT
	PROPOSED 16" GAS LINE (OPEN-CUT)
	PROPOSED 16" GAS LINE (HDD)
	WETLAND
	DOMINION ENERGY PERMANENT EASEMENT

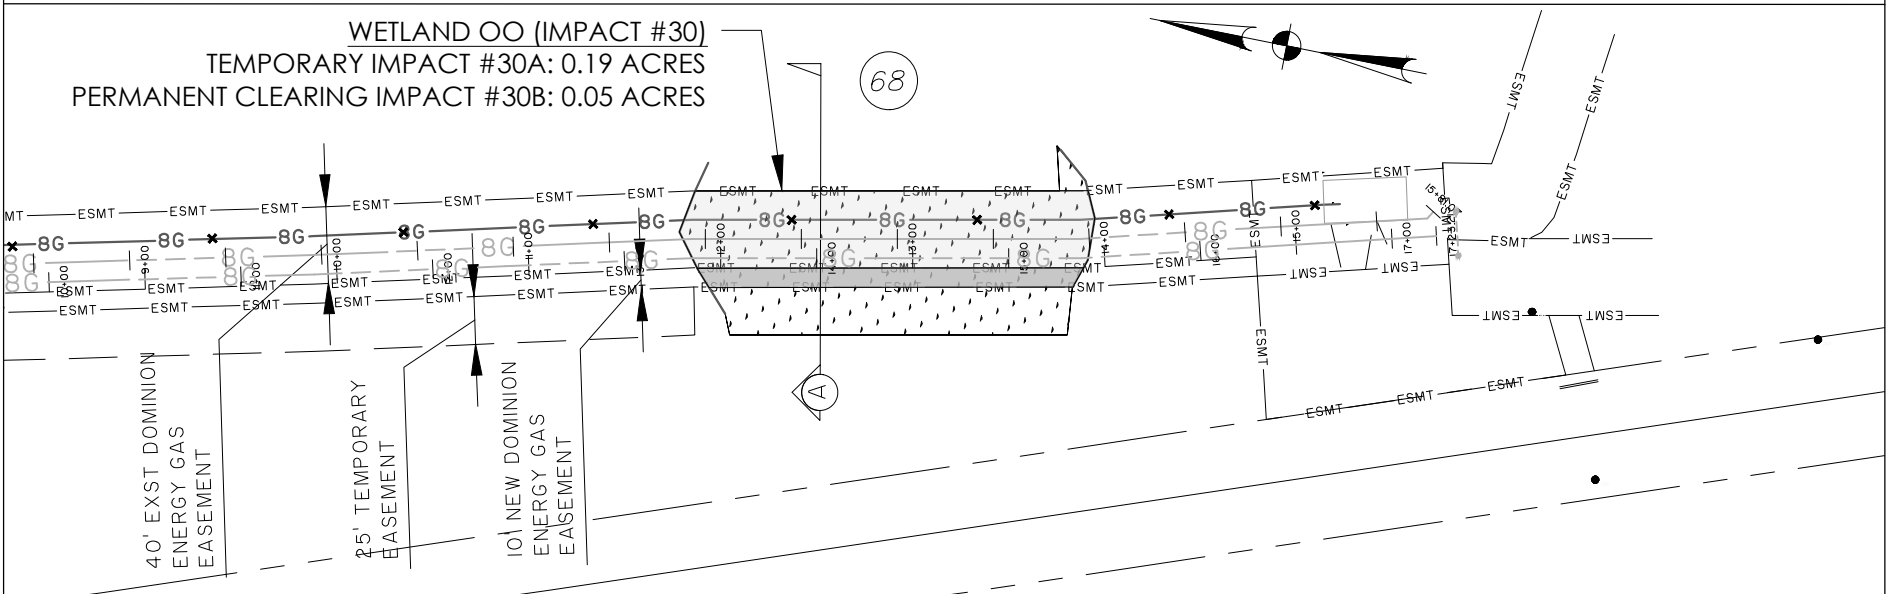
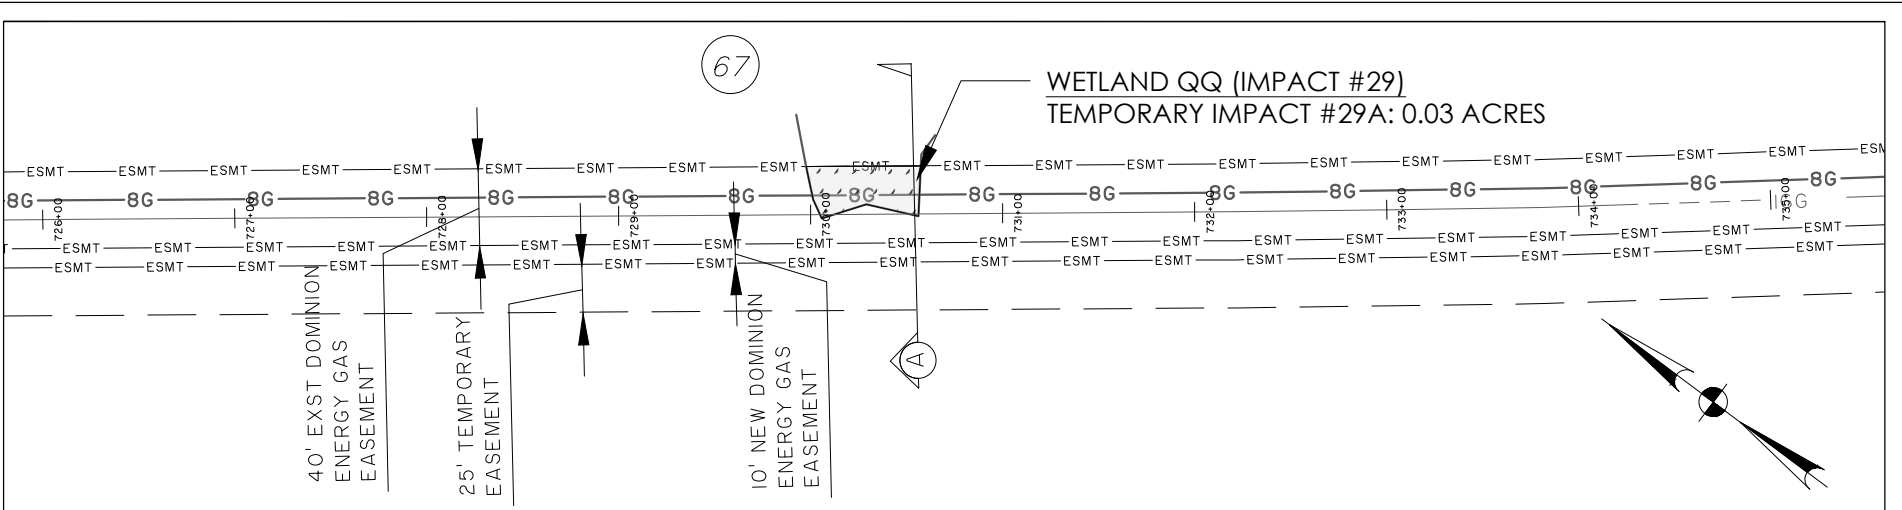
RIVER NECK TO KINGSBURG 16" GAS MAIN

WETLAND IMPACT AREAS 27 AND 28

CLIENT:
DOMINION ENERGY

LOCATION: FLORENCE COUNTY, SC
 DATE: 5/27/2020 DRAWN BY: DNF SHEET: 24
 JOB NUMBER: J-27886.0000 REVIEWED BY: JRS SCALE: 1"=100'

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LEGEND

- TEMPORARY IMPACT
- PERMANENT CLEARING IMPACT
- TEMPORARY CLEARING IMPACT
- PROPOSED 16" GAS LINE (OPEN-CUT)
- PROPOSED 8" GAS LINE (OPEN-CUT)
- PROPOSED 16" GAS LINE (HDD)
- WETLAND
- DOMINION ENERGY PERMANENT EASEMENT

RIVER NECK TO KINGSBURG 16" GAS MAIN

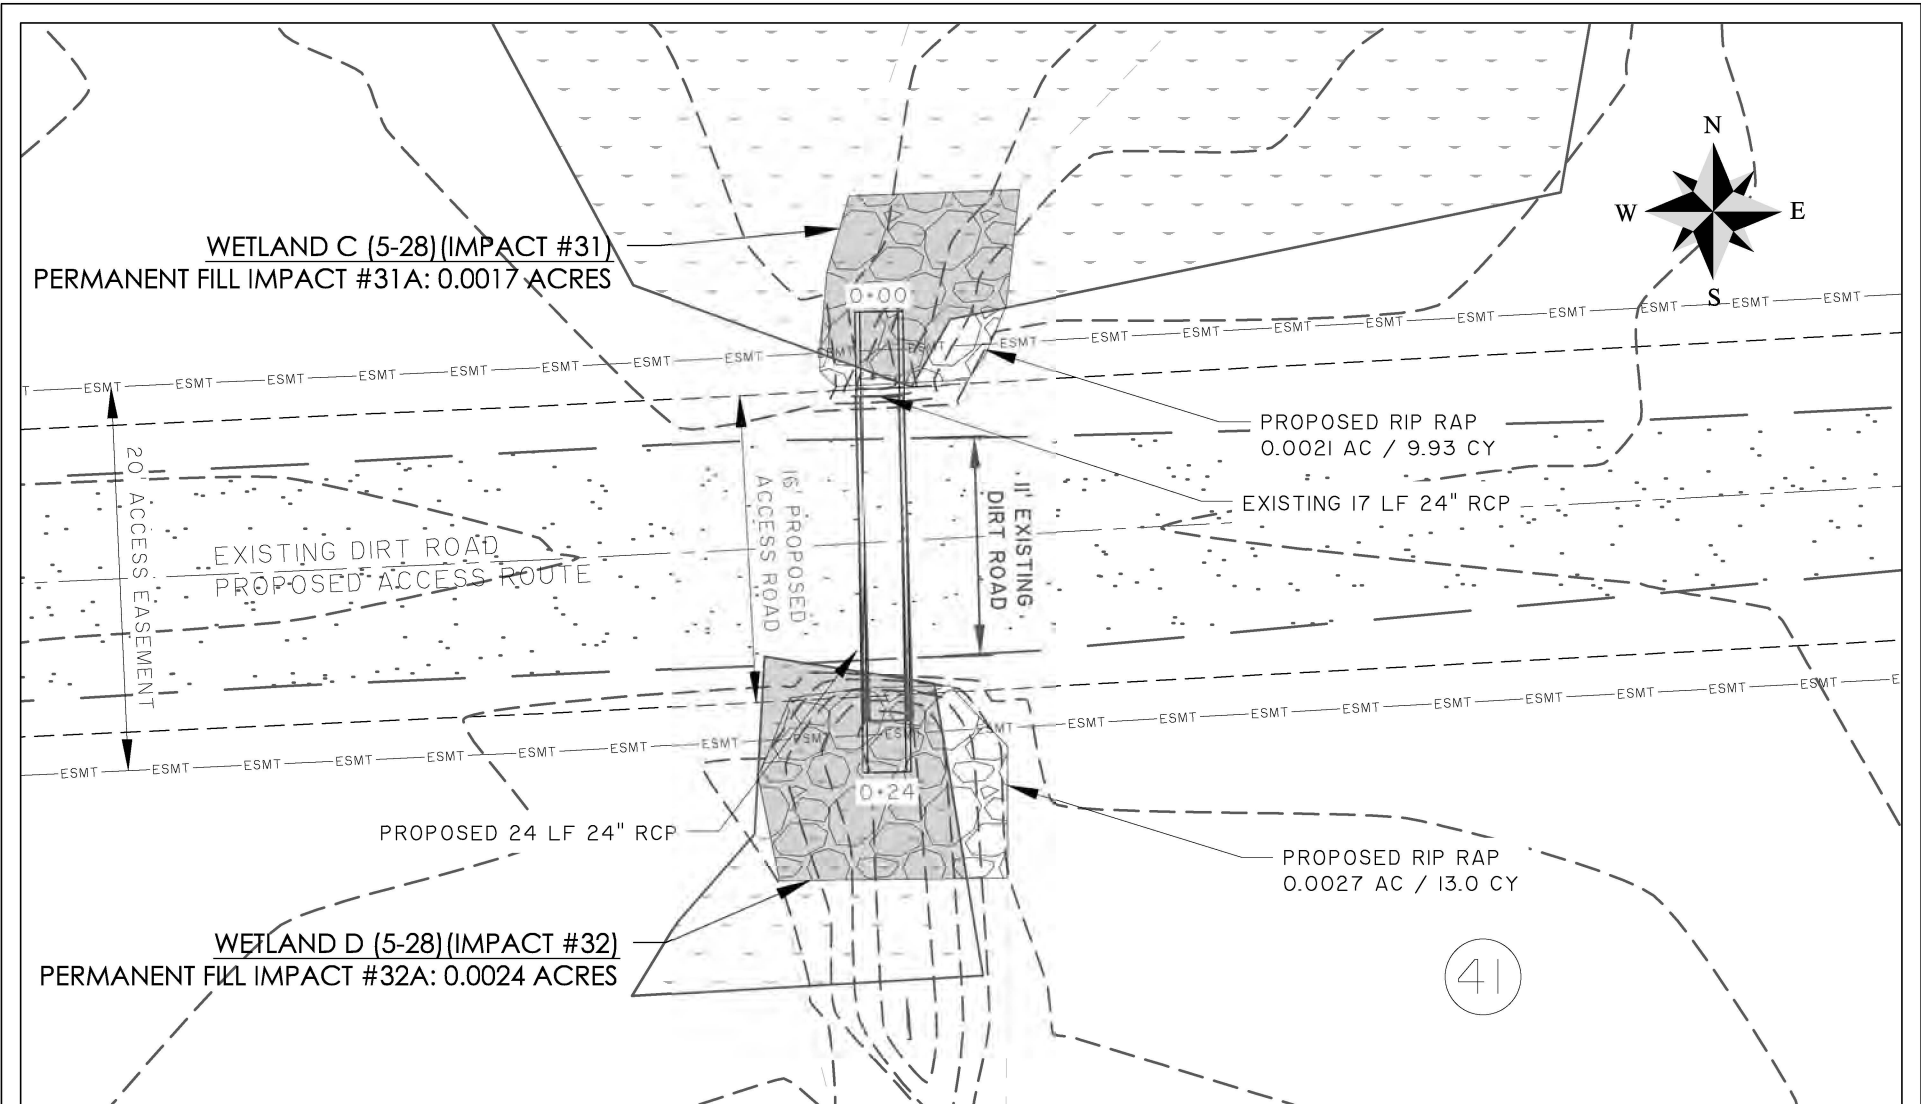
WETLAND IMPACT AREAS 29 AND 30

CLIENT:
DOMINION ENERGY

LOCATION: FLORENCE COUNTY, SC
 DATE: 5/27/2020 DRAWN BY: DNF SHEET: 25
 JOB NUMBER: J-27886.0000 REVIEWED BY: JRS SCALE: 1"=100'

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LEGEND

	TEMPORARY IMPACT
	PERMANENT CLEARING IMPACT
	TEMPORARY CLEARING IMPACT
	PERMANENT FILL IMPACT
	WETLAND
	DOMINION ENERGY PERMANENT EASEMENT

RIVER NECK TO KINGSBURG 16" GAS MAIN

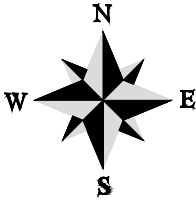
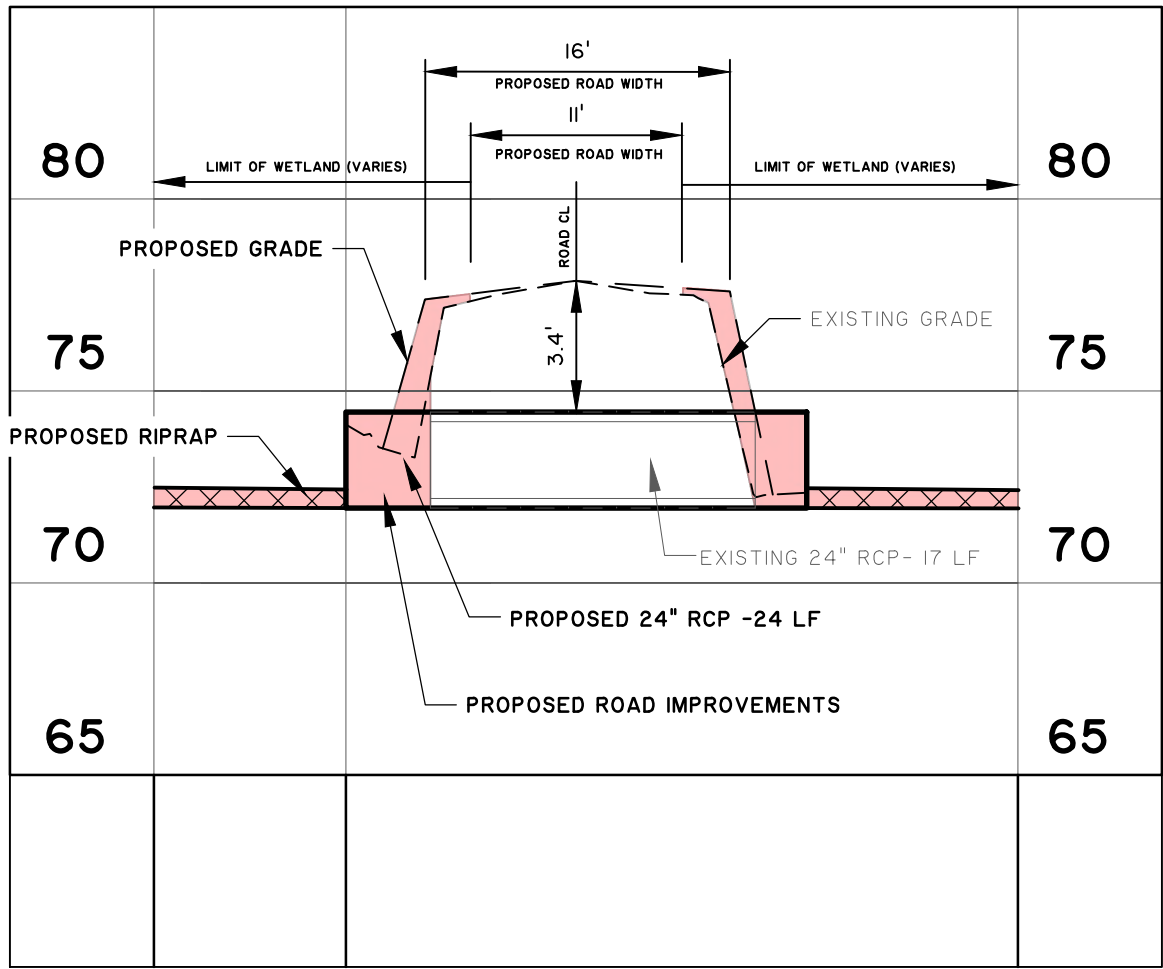
WETLAND IMPACT AREAS 31 & 32

CLIENT:
DOMINION ENERGY

LOCATION: FLORENCE COUNTY, SC
 DATE: 5/27/2020 DRAWN BY: DNF SHEET: 27
 JOB NUMBER: J-27886.0000 REVIEWED BY: JRS SCALE: 1" = 10'

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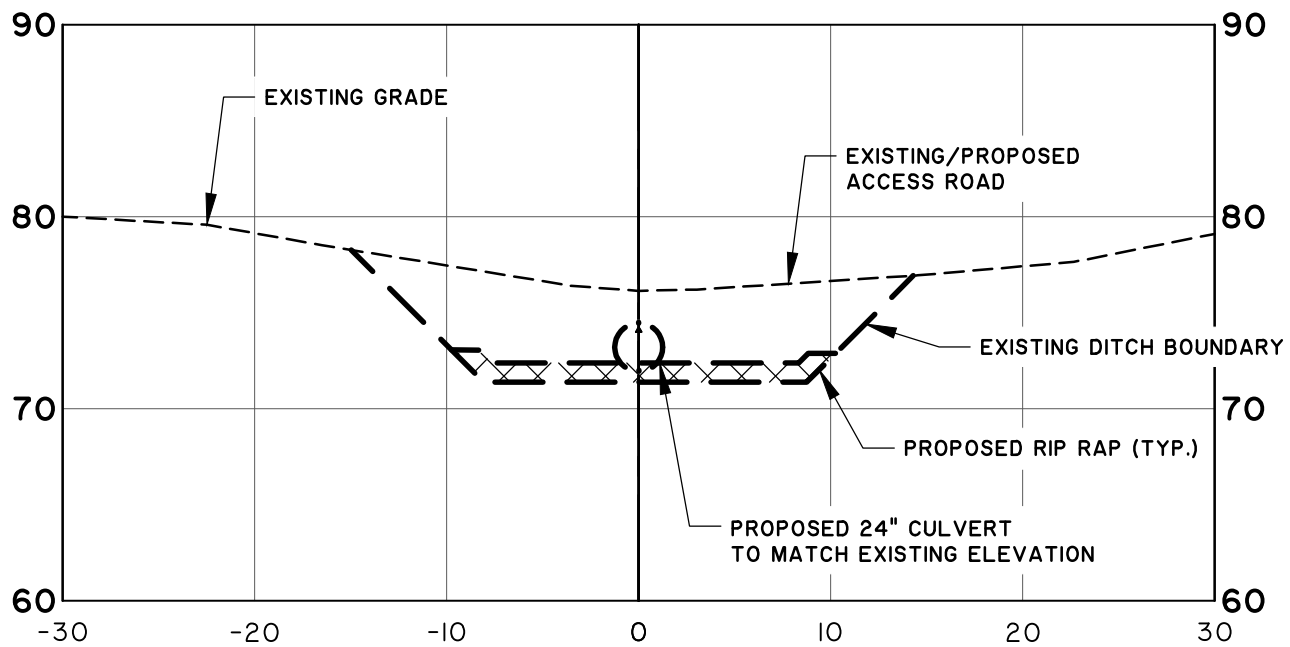
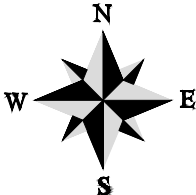
0+00 0+35

TRACT 41 CULVERT

RIVER NECK TO KINGSBURG 16" GAS MAIN
 WETLAND IMPACT AREAS 31 & 32 PROFILE DETAIL
 CLIENT:
 DOMINION ENERGY
 LOCATION: FLORENCE COUNTY, SC
 DATE: 04/21/21 DRAWN BY: DNF SHEET: 28
 JOB NUMBER: J-27886.0000 REVIEWED BY: JRS SCALE: 1" = 10'



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STA: 0+00.14
 SCALE: HORZ.: 1" = 10'
 VERT.: 1" = 10'

RIVER NECK TO KINGSBURG 16" GAS MAIN

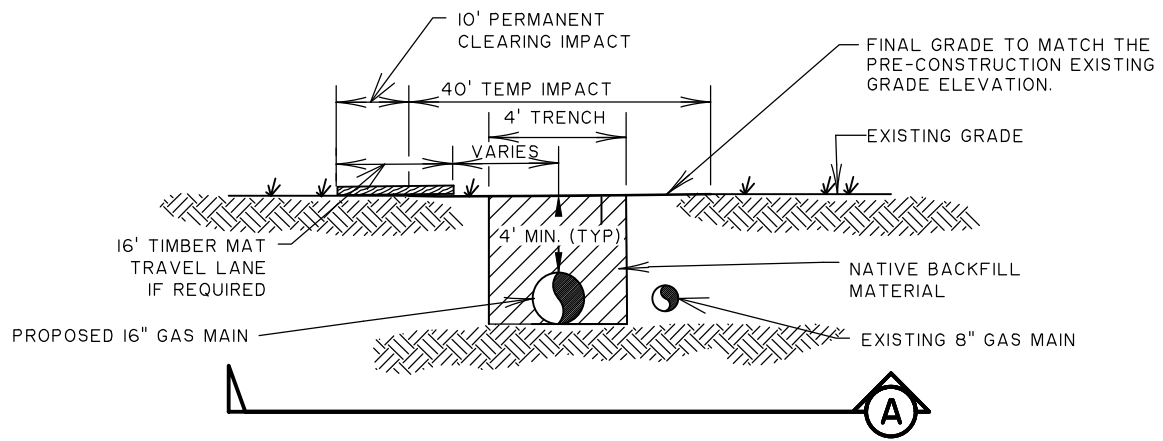
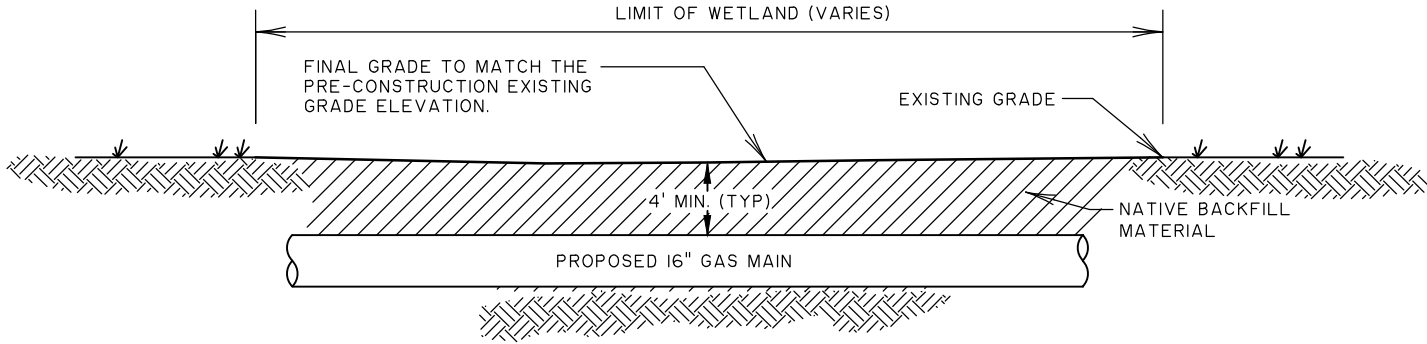
WETLAND IMPACT AREAS 31 & 32 SECTION DETAIL STA 0+00.14

CLIENT:
 DOMINION ENERGY

LOCATION: FLORENCE COUNTY, SC
 DATE: 04/21/21 DRAWN BY: DNF SHEET: 29
 JOB NUMBER: J-27886.0000 REVIEWED BY: JRS SCALE: 1" = 10'



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TYPICAL SECTION "A" - GAS MAIN INSTALLATION WITHIN WETLANDS

NOT TO SCALE

NOTE: CONTRACTOR TO RESTORE WETLANDS TO ITS PRE-CONSTRUCTION CONTOURS.

RIVER NECK TO KINGSBURG 16" GAS MAIN

CROSS SECTION A

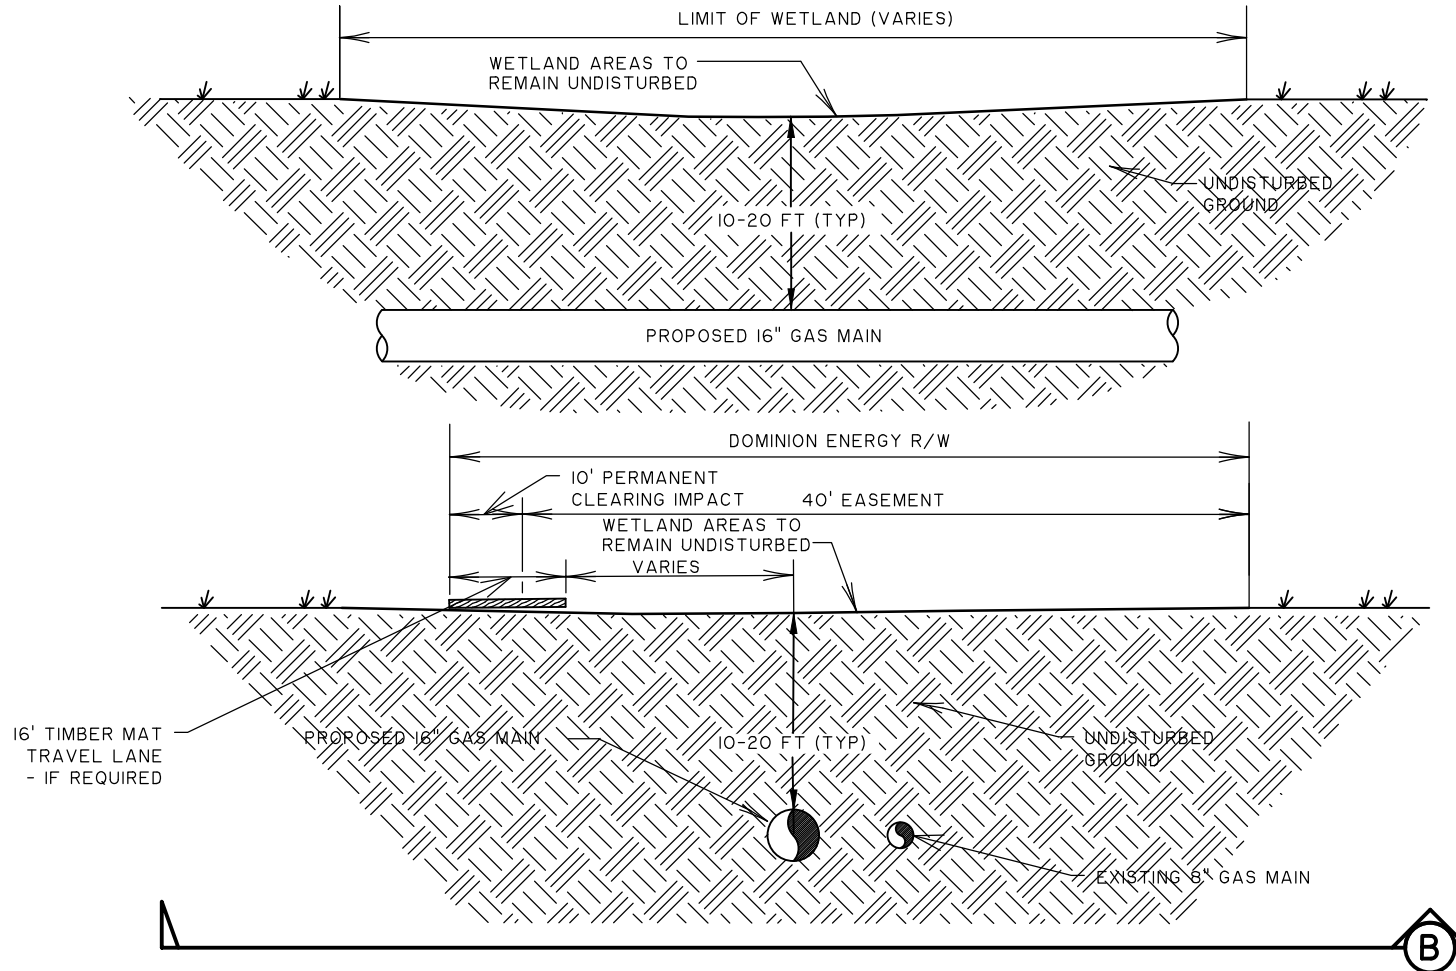
CLIENT:
DOMINION ENERGY

LOCATION: FLORENCE COUNTY, SC
DATE: 04/21/21 DRAWN BY: DNF SHEET: 30
JOB NUMBER: J-27886.0000 REVIEWED BY: JRS SCALE: NTS



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TYPICAL SECTION "B" - GAS MAIN INSTALLATION UNDER WETLANDS BY HDD

NOT TO SCALE

RIVER NECK TO KINGSBURG 16" GAS MAIN

CROSS SECTION B

CLIENT:
DOMINION ENERGY

LOCATION: FLORENCE COUNTY, SC

DATE: 04/21/21

JOB NUMBER: J-27886.0000

DRAWN BY: DNF

REVIEWED BY: JRS

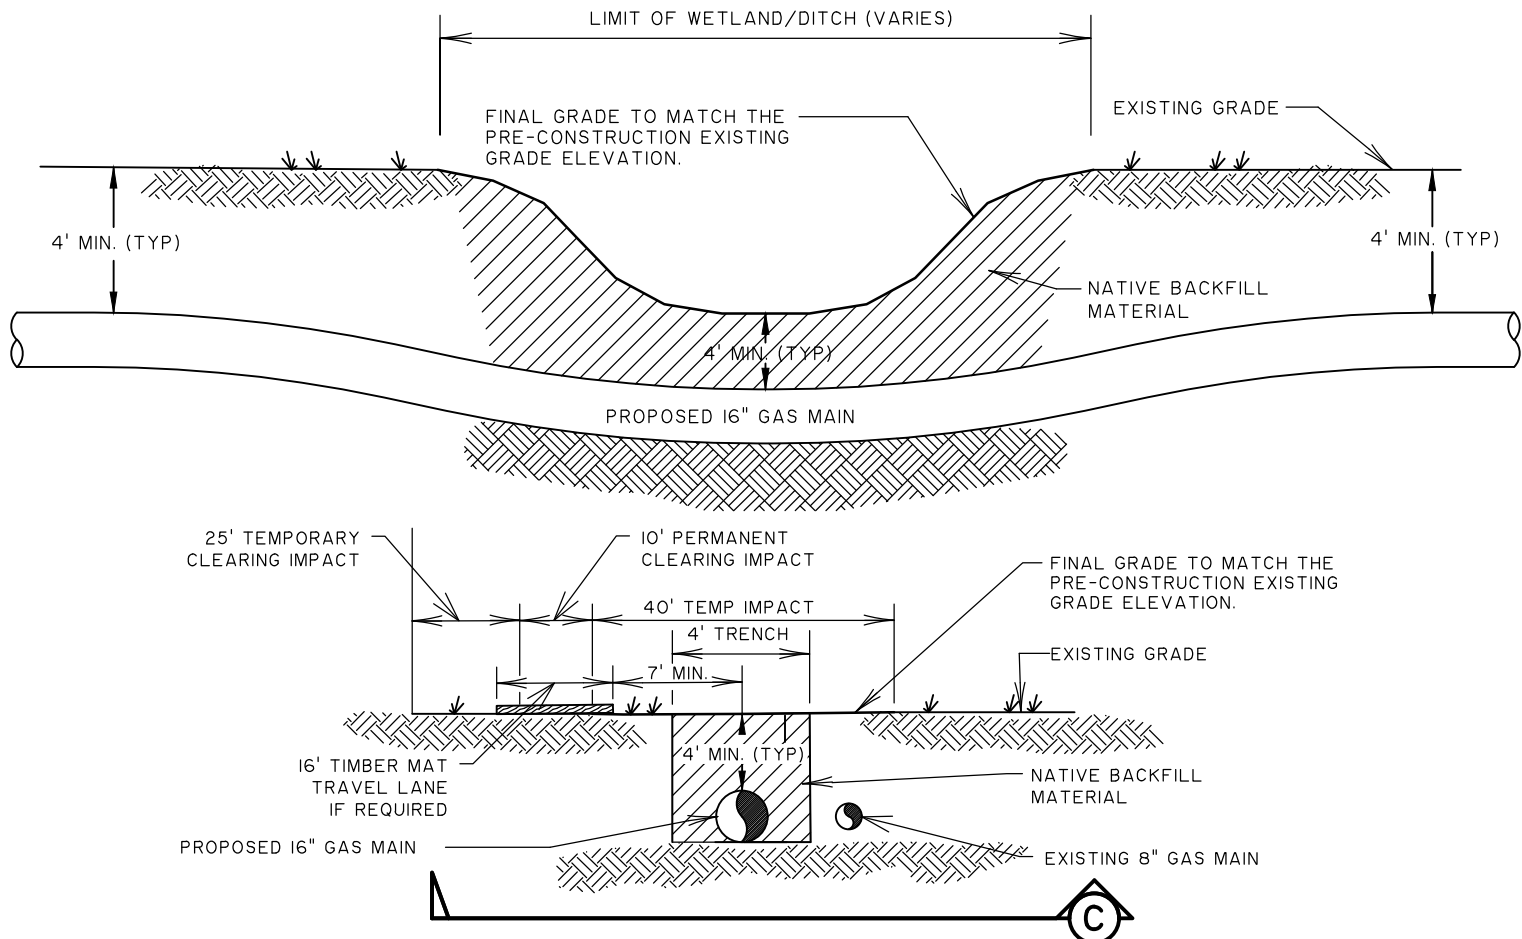
SHEET: 31

SCALE: NTS



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TYPICAL SECTION "C" - GAS MAIN INSTALLATION AT DITCH CROSSINGS

NOT TO SCALE

RIVER NECK TO KINGSBURG 16" GAS MAIN

CROSS SECTION C

CLIENT:
DOMINION ENERGY

LOCATION: FLORENCE COUNTY, SC

DATE: 04/21/21

JOB NUMBER: J-27886.0000

DRAWN BY: DNF

REVIEWED BY: JRS

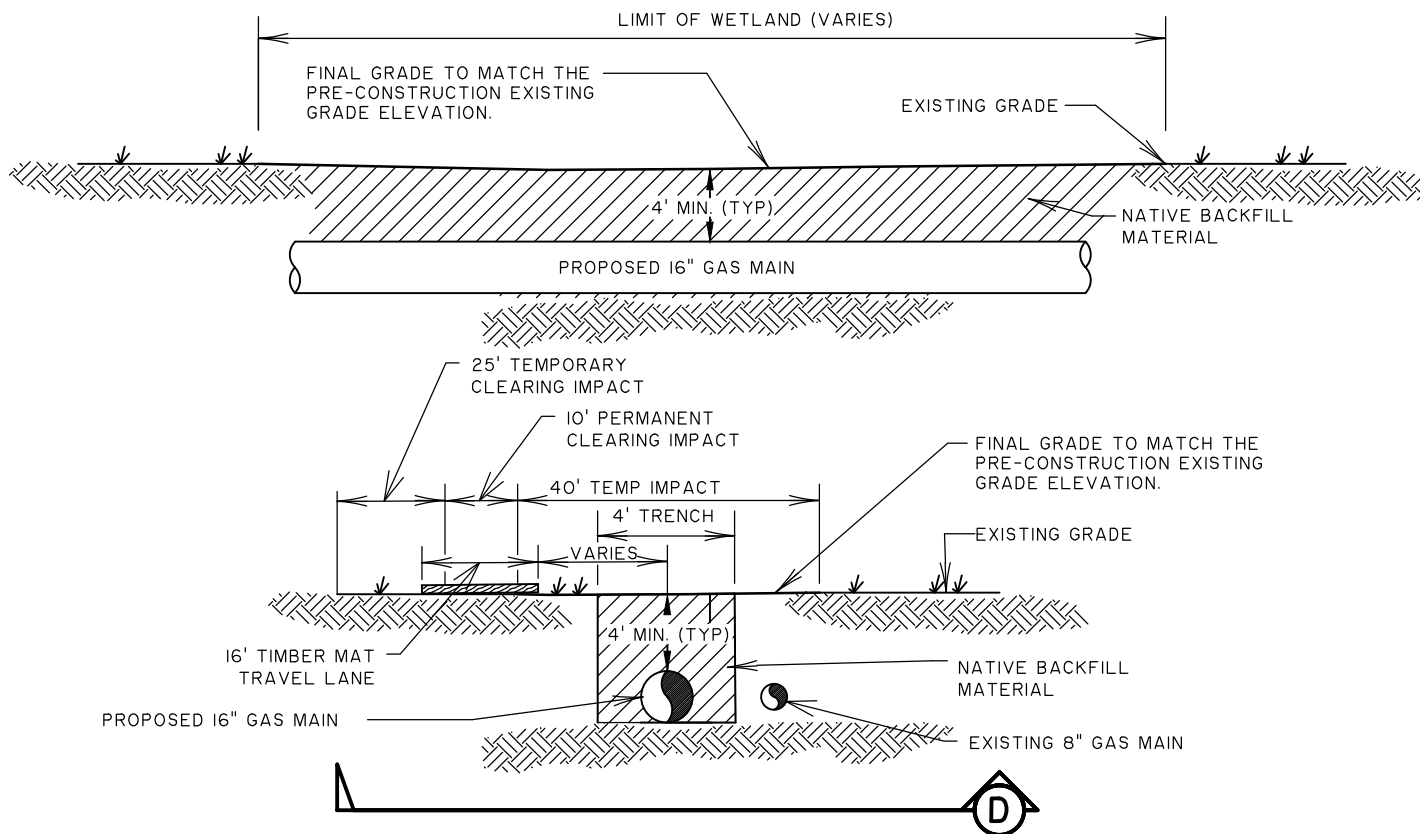
SHEET: 32

SCALE: NTS



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TYPICAL SECTION "D" - GAS MAIN INSTALLATION WITHIN WETLANDS

NOT TO SCALE

NOTE: CONTRACTOR TO RESTORE WETLANDS TO ITS PRE-CONSTRUCTION CONTOURS.

RIVER NECK TO KINGSBURG 16" GAS MAIN

CROSS SECTION D

CLIENT:
DOMINION ENERGY

LOCATION: FLORENCE COUNTY, SC

DATE: 04/21/21

JOB NUMBER: J-27886.0000

DRAWN BY: DNF

REVIEWED BY: JRS

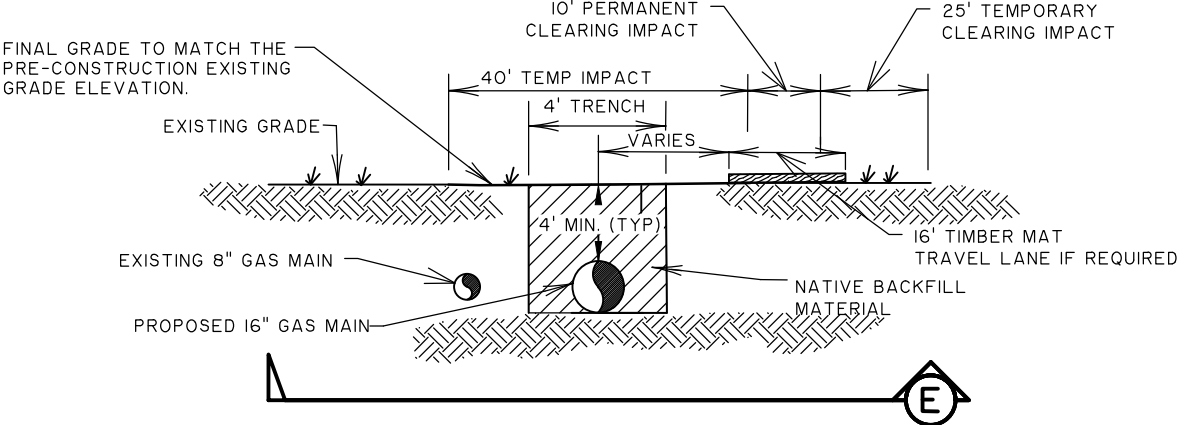
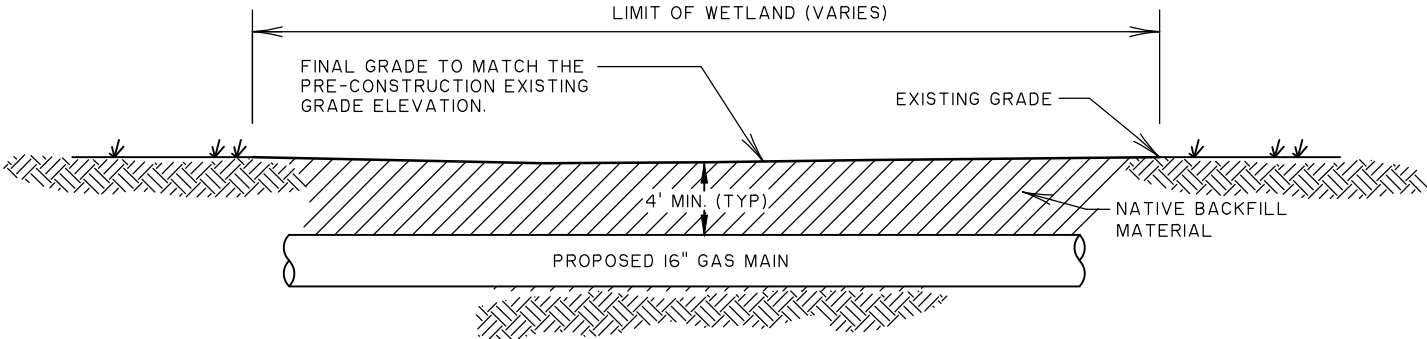
SHEET: 33

SCALE: NTS



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TYPICAL SECTION "E" - GAS MAIN INSTALLATION WITHIN WETLANDS

NOT TO SCALE

NOTE: CONTRACTOR TO RESTORE WETLANDS TO ITS PRE-CONSTRUCTION CONTOURS.

RIVER NECK TO KINGSBURG 16" GAS MAIN

CROSS SECTION E

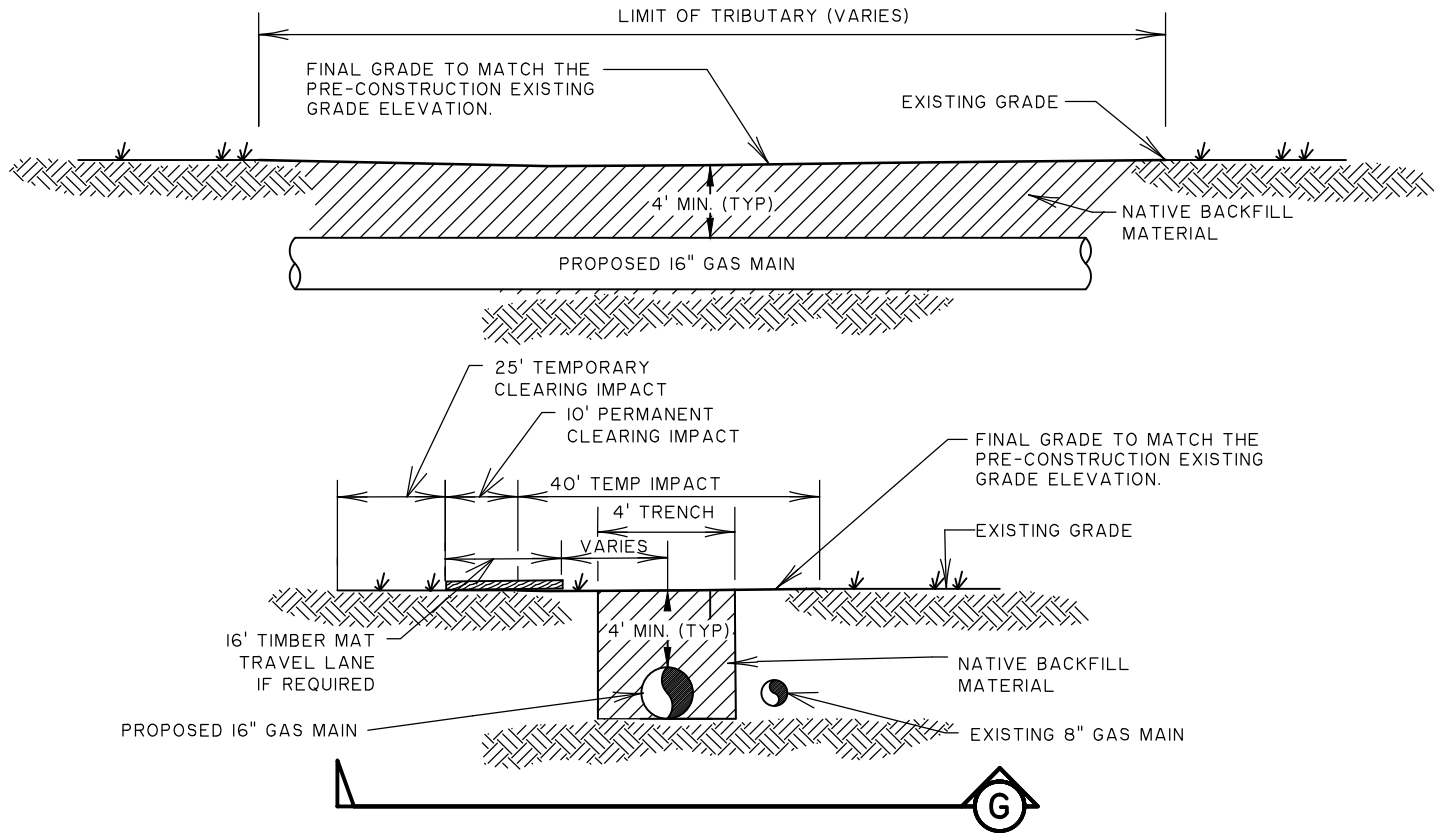
CLIENT:
DOMINION ENERGY

LOCATION: FLORENCE COUNTY, SC
DATE: 04/21/21 DRAWN BY: DNF SHEET: 34
JOB NUMBER: J-27886.0000 REVIEWED BY: JRS SCALE: NTS



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TYPICAL SECTION "G" - GAS MAIN INSTALLATION WITHIN TRIBUTARY

NOT TO SCALE

NOTE: CONTRACTOR TO RESTORE WETLANDS TO ITS PRE-CONSTRUCTION CONTOURS.

RIVER NECK TO KINGSBURG 16" GAS MAIN

CROSS SECTION G

CLIENT:
DOMINION ENERGY

LOCATION: FLORENCE COUNTY, SC

DATE: 04/21/21

JOB NUMBER: J-27886.0000

DRAWN BY: DNF

REVIEWED BY: JRS

SHEET: 36

SCALE: NTS



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WETLAND ID	IMPACT #	TEMPORARY IMPACT (ACRES / LF)		PERMANENT CLEARING IMPACT (ACRES / LF)		PERMANENT FILL IMPACT (ACRES / LF)		TEMPORARY CLEARING IMPACT (ACRES / LF)		WETLAND TYPE	ACREAGE	FEET
B	1	0.110	0.00	0.030	0.00	0.000	0.00	0.000	0.00	WETLAND	0.140	0.00
A	2	5.140	0.00	1.800	0.00	0.000	0.00	5.640	0.00	WETLAND	12.580	0.00
C	3	0.000	0.00	0.060	0.00	0.000	0.00	0.020	0.00	WETLAND	0.080	0.00
D	4	0.000	0.00	0.125	0.00	0.000	0.00	0.000	0.00	WETLAND	0.125	0.00
E	5	0.000	0.00	0.089	0.00	0.000	0.00	0.000	0.00	WETLAND	0.089	0.00
F	6	0.490	0.00	0.120	0.00	0.000	0.00	0.310	0.00	WETLAND	0.920	0.00
G	7	0.270	0.00	0.094	0.00	0.000	0.00	0.140	0.00	WETLAND	0.504	0.00
AA	8	0.180	0.00	0.042	0.00	0.000	0.00	0.000	0.00	WETLAND	0.222	0.00
BB	9	0.013	0.00	0.017	0.00	0.000	0.00	0.000	0.00	WETLAND	0.030	0.00
CC	10	0.007	0.00	0.014	0.00	0.000	0.00	0.000	0.00	WETLAND	0.021	0.00
DD	11	0.020	0.00	0.036	0.00	0.000	0.00	0.000	0.00	WETLAND	0.056	0.00
EE	12	0.011	0.00	0.015	0.00	0.000	0.00	0.000	0.00	WETLAND	0.026	0.00
FF	13	0.160	0.00	0.040	0.00	0.000	0.00	0.000	0.00	WETLAND	0.200	0.00
GG	14	0.008	0.00	0.005	0.00	0.000	0.00	0.000	0.00	WETLAND	0.013	0.00
HH	15	0.130	0.00	0.014	0.00	0.000	0.00	0.000	0.00	WETLAND	0.144	0.00
II	16	0.017	0.00	0.005	0.00	0.000	0.00	0.016	0.00	WETLAND	0.038	0.00
JJ	17	0.410	0.00	0.100	0.00	0.000	0.00	0.000	0.00	WETLAND	0.510	0.00
KK	18	0.040	0.00	0.007	0.00	0.000	0.00	0.000	0.00	WETLAND	0.047	0.00
TRIBUTARY LL	19	0.019	78.00	0.002	11.00	0.0045	22.00	0.008	27.00	NON-WETLAND WATERS	0.034	138.00
MM	20	0.140	0.00	0.030	0.00	0.000	0.00	0.000	0.00	WETLAND	0.170	0.00
NN	21	0.170	0.00	0.050	0.00	0.000	0.00	0.000	0.00	WETLAND	0.220	0.00
H	22	0.190	0.00	0.050	0.00	0.000	0.00	0.120	0.00	WETLAND	0.360	0.00
I	23	0.120	0.00	0.040	0.00	0.000	0.00	0.000	0.00	WETLAND	0.160	0.00
J	24	0.060	0.00	0.020	0.00	0.000	0.00	0.000	0.00	WETLAND	0.080	0.00
K	25	0.250	0.00	0.070	0.00	0.000	0.00	0.000	0.00	WETLAND	0.320	0.00
L	26	0.150	0.00	0.050	0.00	0.000	0.00	0.080	0.00	WETLAND	0.280	0.00
TRIBUTARY SS	27	0.009	41.00	0.002	10.00	0.000	0.00	0.003	26.00	NON-WETLAND WATERS	0.014	77.00
RR	28	0.044	0.00	0.013	0.00	0.000	0.00	0.000	0.00	WETLAND	0.057	0.00
QQ	29	0.030	0.00	0.000	0.00	0.000	0.00	0.000	0.00	WETLAND	0.030	0.00
OO	30	0.190	0.00	0.050	0.00	0.000	0.00	0.000	0.00	WETLAND	0.240	0.00
C (5-28)	31	0.000	0.00	0.000	0.00	0.0017	0.00	0.000	0.00	WETLAND	0.002	0.00
D (5-28)	32	0.000	0.00	0.000	0.00	0.0024	0.00	0.000	0.00	WETLAND	0.002	0.00
Total	--	8.378	119.00	2.990	21.00	0.009	22.00	6.337	53.00	--	17.714	193.00

RIVER NECK TO KINGSBURG 16" GAS MAIN

SUMMARY TABLE

CLIENT:

DOMINION ENERGY

LOCATION: FLORENCE COUNTY, SC

DATE: 5/27/2020

JOB NUMBER: J-27886.0000

DRAWN BY: DNF

REVIEWED BY: JRS

SHEET: 37

SCALE: NO SCALE



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BREAKDOWN OF SITE	
	ACREAGE
TOTAL SITE	212.2
TOTAL WETLANDS WITHIN SITE	20.8
TOTAL NON-WETLANDS WATER WITHIN SITE	0.043

RIVER NECK TO KINGSBURG 16" GAS MAIN

SUMMARY TABLE

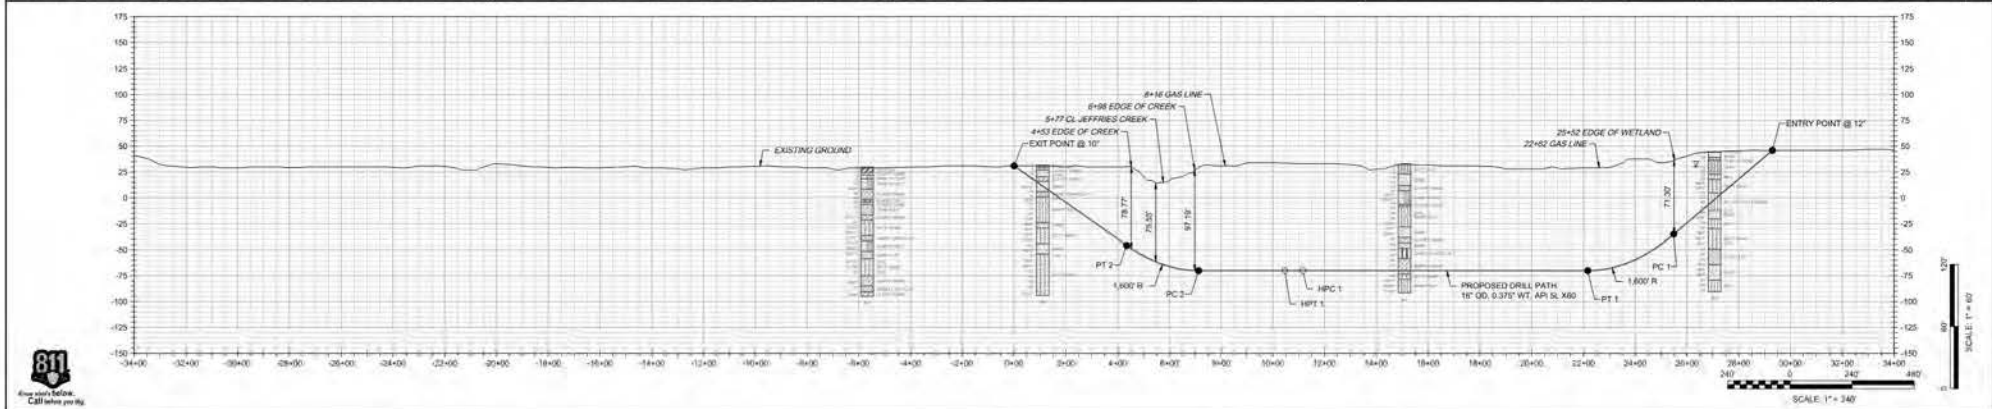
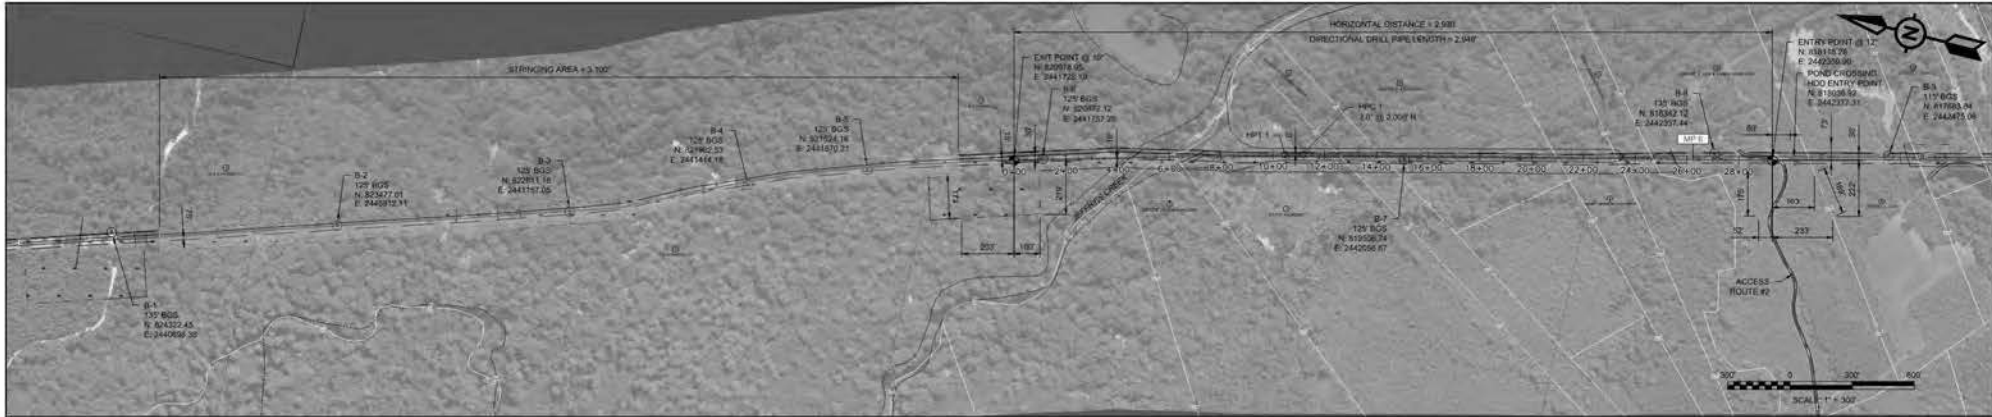
CLIENT:
DOMINION ENERGY

LOCATION: FLORENCE COUNTY, SC	DRAWN BY: DNF	SHEET: 38
DATE: 04/21/21	REVIEWED BY: JRS	SCALE: 1" = 1'
JOB NUMBER: J-27886.0000		



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DIRECTIONAL DRILL DATA		
DESCRIPTION	STATION (ft)	ELEVATION (ft)
ENTRY POINT @ 12'	28+00.00	45.58
PC 1 (11.800' R)	28+46.62	-35.04
PT 1	29+16.28	76.00
HPC 1 (2.0' @ 3.000' R)	31+16.60	-76.00
HPT 1	31+45.75	-76.30
PC 2 (1.800' R)	31+72.77	76.00
PT 2	33+34.83	-48.88
EXIT POINT @ 10'	34+00.00	31.58
HORIZONTAL DISTANCE (ft) = 2630.00		
DIRECTIONAL DRILL PIPE LENGTH (ft) = 2949.08		

- GENERAL NOTES**
- DRILL PATH STATIONING IS IN FEET BY HORIZONTAL MEASUREMENT AND IS REFERENCED TO THE CONTROL POINT FOR THE CROSSING.
 - ALL COMPANY SPECIFICATIONS, PERMIT REQUIREMENTS AND CONTRACT DOCUMENTS SHALL BE ADHERED TO BY CONTRACTOR.
 - CONTRACTOR SHALL PLACE ONE CALL 811 NOTIFICATIONS AND ADOBE BY STATE REGULATIONS BEFORE DRILLING COMMENCES.
 - PRESENCE, LOCATION AND ELEVATIONS (PROFILES IF NEEDED) OF ALL UTILITIES/FACILITIES TO BE VERIFIED BY CONTRACTOR PRIOR TO CONSTRUCTION AND CLEARLY MARKED AND EXPOSED (IF NECESSARY).
 - DRILLING PRACTICES AND DOWNHOLE ASSEMBLIES SHALL BE MODIFIED TO PREVENT DAMAGE TO UNDERGROUND FACILITIES.
 - CONTRACTOR SHALL MONITOR TRENCHLESS OPERATIONS FOR AREA IMPACTS SUCH AS GROUND DISTURBANCE AND MALDIVERGENT RETURNS.
 - PILOT HOLE TOLERANCES AND MINIMUM THREE (3) INCH RADIUS SHALL BE MAINTAINED DURING PILOT HOLE OPERATIONS COMPROMISE TO TOLERANCES AND MINIMUM RADIUS SHALL BE REVIEWED BY COMPANY FOR APPROVAL.
 - CONTRACTOR HAS THE OPTION TO USE DUAL HOLES AND/OR THE PLACEMENT IN REFERENCE TO ENTRY AND EXIT.

- GEOTECHNICAL DATA AND INFORMATION IS PRESENTED FOR REFERENCE ONLY. REVIEW THE ASSOCIATED GEOTECHNICAL REPORT FOR ALL INTERPRETATIONS AND DETERMINATIONS REGARDING SUBSURFACE CONDITIONS.
- PROJECT TOLERANCES SHALL NOT SUPERSEDE ANY PILOT HOLE ENCROACHMENT THAT COMES WITHIN 3 FEET OF THE RADIUS/CHORD COORDINATES AT ANY LOCATION, UNLESS TO 1/8" ALIGNMENT.

MATERIAL SPECIFICATIONS AND TOLERANCES	
ITEM	SPECIFICATIONS
PRODUCT #/REV	18" OD, 0.375" WT, API 5L X60
EXTERNAL COATING	15-16 MILS F50E 40-40 MILS AMG
OPERATING CONDITIONS	DRAG - 100T ASSUMED MAXIMUM OPERATING TEMP = 100°F
TOLERANCE	
PILOT HOLE ENTRY ANGLE	INCREASE ANGLE UP TO 1° (STEEPER), NO DECREASE IN ANGLE ALLOWED
PILOT HOLE ENTRY LOCATION	AS PER COORDINATES PROVIDED BY COMPANY AND CHANGES WITHOUT COMPANY APPROVAL
PILOT HOLE EXIT ANGLE	INCREASE ANGLE UP TO 1° (STEEPER) OR DECREASE UP TO 2° (FLATTER)
PILOT HOLE EXIT LOCATION	UP TO 25 FEET BEYOND OR 15 FEET SHORT OF THE EXIT SWAGE. BETWEEN 6 FEET LEFT AND 6 FEET RIGHT OF CENTERLINE
PILOT HOLE DEPTH	UP TO 25 FEET BELOW THE DESIGN DRILL PROFILE OR 10 FEET BELOW THE DESIGN DRILL PROFILE
PILOT HOLE ALIGNMENT	SHALL REMAIN WITHIN 5 FEET LEFT OR RIGHT OF THE HOD CENTERLINE
MINIMUM RADIUS OF CURVATURE	MINIMUM COMBINED (HORIZONTAL AND VERTICAL) RADIUS OF CURVATURE = 1,200' OVER EACH 2.0 INCH SEGMENT

LEGEND

- PROPOSED DRILL PATH
- PROPOSED PIPELINE
- DAIL LINE
- OVERHEAD POWER
- EXISTING EASEMENT
- TEMPORARY WORKSPACE
- PROPERTY LINE
- FENCE LINE
- ACCESS ROUTE
- WATERWAY CL
- EDGE OF WATER
- STIRRING AREA
- WETLAND
- CULTURAL RESOURCES SITE
- PROPOSED HOD ENTRY POINT
- GEOTECHNICAL BORE LOCATION
- MATERIAL GRAPHIC CONTENT
- WATER LEVEL DURING SAMPLING
- WATER LEVEL AFTER SAMPLING

ISSUED FOR PERMIT ONLY

REV	DATE	REVISION DESCRIPTION	APPROVAL		
			CAD	CHK	APP

HDR ENGINEERING INC. OF THE CAROLINAS
445 SOUTH CHICKEN STREET, SUITE 1100
CHARLOTTE, NC 28202
404.299.8100

Dominion Energy

PROJECT INFORMATION		DRAWING INFORMATION	
DOMINION ENERGY RIVER NECK TO KINGSBURG 16-INCH GAS MAIN		16-INCH JEFFERS CREEK CROSSING HORIZONTAL DIRECTIONAL DRILL PLAN AND PROFILE OPTION A PERMIT DRAWING	
COORDINATE SYSTEM	NAD83 SOUTH CAROLINA STATE PLANE - INTERNATIONAL FEET	LOCATION	FLORENCE COUNTY, SOUTH CAROLINA
VERTICAL DATUM	NAVD83	SCALE	SHEET
TOPOGRAPHIC DATA	CLETON ASSOCIATES SURVEYING, INC.	NOTED	BSA: 10239249-02T-5-003
ADJUSTED DATA	CLETON ASSOCIATES SURVEYING, INC.		
SURVEY CONTROL	CS SURVEYING, INC.		



DATE PLOTTED: 10/23/21



HDD Inadvertent Return Contingency Plan
Dominion Energy – River Neck to Kingsburg 16" Gas Main
Florence County, South Carolina
Thomas & Hutton Project Number 27886.0000

PREPARED FOR:

Dominion Energy
601 Old Taylor Road
Cayce, SC 29083

PREPARED BY:

Thomas and Hutton Engineering
682 Johnnie Dodds Blvd. Suite 100
Mt. Pleasant, SC 29464

June 4, 2020

HDD Inadvertent Return Contingency Plan Dominion Energy – **River Neck to Kingsburg 16” Gas Main**
Florence County, South Carolina
T&H Project Number 27886.0000



June 4, 2020

Dominion Energy
601 Old Taylor Road
Cayce, SC 29083

Attention: Mr. Robert Priester, P.E.

Reference: **HDD Inadvertent Return Contingency Plan**
Dominion Energy – River Neck to Kingsburg 16” Gas Main
Florence, South Carolina
T&H Project Number: 27886.0000

Dear Mr. Priester:

Thomas and Hutton Engineering (T&H) is pleased to submit this HDD Inadvertent Return Contingency Plan for the above-referenced pipeline project that runs from River Neck Road to the Kingsburg Valve Station in Florence County, South Carolina. This report is provided in accordance with our plans dated April 10, 2020. The report is based on horizontal direction drill (HDD) design information provided by Thomas & Hutton. The purpose of this report is to provide guidance in order to help avoid an inadvertent return during HDD construction activities.

T&H appreciates the opportunity to assist you during this phase of the project. If you have questions concerning this report, please contact us.

Sincerely,

Thomas & Hutton

A handwritten signature in blue ink, appearing to read 'Jonathan Smith', written over a light blue horizontal line.

Jonathan Smith, PE
Project Manager



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Appendices

Appendix I - IR Contingency Minimum Required Equipment List



1.0 Introduction

Dominion Energy is proposing to construct approximately 76,218 LF of new 16-inch diameter steel natural gas main that runs from River Neck Road to the Kingsburg Valve Station in Florence county, South Carolina. The project route will begin with a connection to an existing gas regulating station at River Neck Road. The gas main will run within an existing Dominion Energy easement paralleling Dominion Energy’s existing 8-inch steel gas main. The 16-inch gas main will continue southeast for 14.5 miles where it will terminate at the Kingsburg Valve Station. The new pipeline will be completed by a combination of open-cut trench and horizontal directional drill (HDD). All work will be performed in an existing Dominion Energy utility easement.

HDD operations have the potential for Inadvertent Returns (IR) of drilling fluids, or unintended release of drilling fluids, during the HDD installation process. IRs occur due to migration of drilling fluids through subsurface formations or soils other than the bore annulus and can be released to the ground surface, surface waters and/or migrate to neighboring aquifers. Drilling fluids utilized during HDD activities primarily consist of bentonite clay and water mixtures and are often referred to as drill mud. Small amounts of chemical additives (typically less than 1%) may be mixed with the drilling fluids to improve drilling performance, or in response to a release. Though not classified as toxic or hazardous, these drilling fluids may adversely impact aquatic and/or terrestrial ecosystems if an IR occurs.

Dominion Energy is committed to verifying that all project construction activities will be completed in an environmentally responsible manner. Accordingly, this Inadvertent Return Contingency Plan has been developed and outlines procedures to:

- Minimize the potential for an IR.
- Detect the first indications of an IR.
- Prepare the HDD contractor so their response to an IR will be organized, timely and appropriate to minimize environmental impacts.
- Verify that notifications to appropriate parties and regulatory agencies are made.

Detailed designs have been prepared and geotechnical assessments are planned for both HDD crossings. These designs establish borehole line and grade, evaluate pipeline installation and operating stresses, evaluate geotechnical conditions along the bore path, and identifies known surface and subsurface utilities and obstructions. Based on these designs, the selected HDD Contractor can effectively pre-plan the drilling work and prepare their project-specific risk management and contingency strategies. This report can be updated once design and geotechnical work is completed.

2.0 Inadvertent Return Prevention Measures

In order to minimize potential environmental impacts associated with IRs, HDD profile designs have been created, and planning for specific measures to be taken before, during, and after the HDD installation process have been completed.

HDD Inadvertent Return Contingency Plan Dominion
 Energy – **River Neck to Kingsburg 16” Gas Main**
 Florence County, South Carolina
 T&H Project Number 27886.0000



2.1 Bore Profile Design

HDD profile designs have been created using surface profile information and will be augmented with geotechnical assessment data. Survey information has been used to design the drill profile such that potential obstacles are avoided and an acceptable depth below the stream/wetlands is achieved. The geotechnical data will be used to determine if the geologic soils and formations that are being drilled through will allow for effective steering and control along the bore path and are conducive to containment of the drill mud. This information, combined with HDD designer experience, will help to minimize the risks of an IR.

2.2 Pre-Drill Preventive Measures

Before the start or continuance of both of the HDDs, the following measures shall be implemented:

2.2.1 *HDD Drilling Supervisor*

The HDD Contractor shall have a HDD Drilling Supervisor present at all times during HDD operations. The HDD Drilling Supervisor is responsible for making sure the HDD is implemented in accordance with the design. The Drilling supervisor shall also confirm that all personnel are: 1) aware of their responsibilities if an IR occurs; 2) aware of the location and proper deployment of materials and cleanup methods, and; 3) are capable of completing the required actions.

2.2.2 *Dominion Energy Environmental Inspector*

A Dominion Energy Environmental Inspector shall be on-site and shall verify that:

- Construction limits are clearly marked.
- Sensitive resources within, and adjacent to, the construction workspaces are flagged.
- All required clearances or permits related to sensitive features have been obtained.
- All setbacks and offsets from sensitive resources shall be maintained.
- Coordination with the USACE and SCDHEC to communicate anticipated HDD schedule has occurred.
- Erosion and sediment controls are appropriate for the current and expected conditions, have been installed, and are functioning properly.
- A properly-stocked spill response kit is present at the drill site.
- Appropriate response equipment is on-site and in good working order (Minimum required equipment is listed in Appendix II but may be modified by the Dominion Energy Environmental Inspector based on current and expected conditions at the site at the time of installation).
- A pre-construction meeting is conducted with contractor personnel to identify and locate sensitive resources at the site and to review the Inadvertent Return Contingency Plan for the HDD.
- Subsequent daily briefings with contractor personnel are conducted.

2.2.3 *HDD Contractor*

The HDD Contractor shall perform the HDD utilizing reasonable measures to minimize the risk of IRs while ensuring the completion of a successful HDD. These measures include, but are not limited to, the following:



2.2.3.1 Monitoring of Mud Quality

Monitoring of drilling fluid (mud) pressures, viscosities, circulation, and returns shall be completed during all drilling activities to verify that the mud handling equipment is operating within the expected parameters of the anticipated soil conditions. The soil returns will be continuously monitored, and adjustments made as necessary.

2.2.3.2 Controlled Drill Head Advance

The HDD Operator will advance the drill head at a pace that permits sufficient time for soil cuttings to be flushed from the borehole by the drilling fluids. Attempting to advance the drill head too quickly can cause plugging to occur due to build-up of cuttings in the annular space. Continuing to advance the drill head when plugging has occurred will cause annular space pressures to increase, which could lead to an IR. If plugging occurs, the drill head advance shall be slowed, stopped, or reversed as necessary to clear the build-up of cuttings. Swabbing the drill hole may also be required to clear excess build-up of cuttings.

Drilling mud pump pressure will be maintained at a level above the minimum pressure required to keep the annular space clear of cuttings and promote good drilling fluid circulation. However, this pressure should not be exceeded more than is necessary and should be maintained well below the maximum allowable annular mud pressure. Calculations will be completed to provide the minimum and maximum mud pressures along the drill path based off the provided geotechnical and surface survey information.

2.2.3.3 Proper Tool and Equipment Sizing

Appropriately sized (diameter) drill heads and reamer bits will be used to maintain proper annular space size through the drill, especially in the curves of the drill path. This will allow sufficient annular space for the circulation of drilling fluids. An appropriately sized drill rig shall also be selected so that the HDD can be completed successfully.

2.2.4 *Contacts*

- Robert Priester – Engineering and Construction Project Manager – Phone: (803) 217-9815
- Patrick Coolidge – Engineering and Construction Manager – Phone: (803) 331-9221
- A. Robert Schwartz – Environmental Lead – Phone: (803) 217-7112
- Candis Hollowood – Environmental Compliance Coordinator – Phone: (803) 542-2723

3.0 **IR Monitoring**

The HDD Contractor will verify that operations are monitored for the occurrence of IRs using each of the following methods, as appropriate:

3.1 **Mud Pressure Monitoring**

The HDD Contractor is responsible for continually monitoring mud pressures during all HDD activities. Sudden loss of mud pressure could indicate an IR to the surface, loss of fluid into a pre-existing void or fractured rock, blockage of the return path, or borehole collapse. Upon loss of mud pressure, investigation of the cause of mud pressure loss should commence. Drilling activities should be slowed or cease, and mud flow from the pump should be slowed until the cause is determined.



3.2 Ground Surface Inspection

Visual inspection of the ground surface for indications of escaping drilling fluids shall be completed along the path of the HDD, with priority given to environmentally-sensitive areas. To the extent practicable, and without trespassing outside the approved workspace, the inspection should cover a corridor that is at least 300 feet wide, centered on the drill. Inspections shall be made relative to the rate of advance of the drill head; however, a full-length inspection pass shall be made at least once every hour while pumping drilling fluids. Indications of a release shall be reported immediately to the HDD Drilling Supervisor and Dominion Energy Pipeline Inspector.

3.3 Surface Water Inspection

Inspection passes shall be made at least once every hour while pumping. Indications of an IR shall be reported immediately to the HDD Drilling Supervisor and Dominion Energy Pipeline Inspector. If operating parameters indicate the possibility of an IR under water, the water inspection will become continuous (during daylight only) until the location of the suspected inadvertent release is found, the drill is completed, or measures to remedy the inadvertent release using approved additives or other operations adjustments have been successful. Inspections will be made from an elevated position on land with an unobstructed view of the water body. If required, completion of turbidity sampling that might indicate an IR is occurring will be taken at sites upstream and downstream of the HDD crossing.

4.0 Response Measures

Contractor personnel are responsible to report indications of an IR or an observed IR to the on-site Dominion Energy Pipeline Inspector. If either of these conditions are reported and confirmed, HDD operations are to immediately cease. HDD activities shall not resume until cleanup procedures are complete and appropriate agencies have authorized resumption of work.

Containment and removal of drilling fluid releases to the surface will be performed where practical and where there will be a net benefit in the reduction of overall environmental impacts. Response actions will be coordinated through the on-site Dominion Energy Environmental Inspector, Dominion Energy Pipeline Inspector, Dominion Energy Gas Transmission Construction Manager and Dominion Energy Environmental Lead.

4.1 Loss of Drilling Fluid Circulation

As stated in section 3.1, mud pressure loss and fluid circulation loss can indicate an IR at the surface. In the event of loss, or reduction, of drilling fluid circulation the following measures should be taken:

Notify the Dominion Energy Pipeline Inspector and Dominion Energy Environmental Inspector of the loss of fluid circulation.

- Retract the drill head a short distance, if deemed appropriate.
- Discontinue drilling operations to investigate the loss of fluid circulation.
- Pump drilling fluid into the borehole for approximately 15 minutes without advancement of the bore head.
- If fluid circulation is regained, resume drilling operations. The HDD Drilling Supervisor will notify the Dominion Energy Pipeline Inspector, Dominion Energy Environmental Inspector, and Dominion Energy Environmental Lead and continue visual monitoring of the project area for signs of drilling fluid release.
- If a drilling fluid release is detected, discontinue drilling and implement mitigation measures as detailed in



this contingency plan.

- HDD Contractor shall monitor and adjust fluid properties, fluid volumes, and rate of penetration to match ground conditions and maintain circulation and borehole stability once drilling operations resume.

4.2 Notifications and Documentation

If there is an IR or other environmental or safety incident, the HDD Contractor shall report the incident to the on-site Dominion Energy Environmental Inspector or Dominion Energy Pipeline Inspector immediately and directly. The Dominion Energy Environmental Lead will be responsible for making the appropriate regulatory agency notifications.

Documentation of the IR shall include:

- Initial indication/observation of the IR and time observed.
- Location of the IR.
- Resources impacted by the IR.
- Location of the drill head/reamer.
- Stage of the HDD.
- Times of notification and who was notified.
- Actions taken in response to the IR and times those actions were taken.
- Amount of drilling fluid loss.
- Containment methods employed.
- Effectiveness of containment methods.
- Photos (before, during and after cleanup).

4.3 Terrestrial (Upland) Releases

The HDD Drilling Supervisor will utilize the appropriate combination of hay bales, silt fence, compost filter sock, wattles, pumps, hoses, and other measures that will most effectively contain and remove drilling fluids from upland areas. The HDD Drilling Supervisor shall make the determination of the appropriate equipment and materials to be used, with approval of the Dominion Energy Pipeline Inspector and Dominion Energy Environmental Inspector. The actions may include:

- Constructing a small pit or sandbag coffer around the IR location(s), installing a section of silt fence, compost filter sock, and/or hay bales to trap as much drilling fluids as possible, and placing a pump hose in the pit to pump the drilling fluid back to the bore site or temporary holding area or vessels (i.e. vac truck).
- Reducing drilling fluid pressures.
- Thickening drilling fluid mixture; and/or
- Adding pre-approved loss circulation materials to the fluid mixture, such as wood fibers or shredded paper.

If the HDD Contractor determines the fluids are reusable, the HDD Contractor shall instruct the recovery crew to pump the contained and recovered fluids to on-site tanks for reuse. Otherwise, the fluids will be transported off-site for disposal at an approved facility. Dominion Energy will obtain landowner permission prior to accessing upland sites for fluids containment and removal operations, except in emergency cases where inaction would pose an imminent threat to human health, environmentally sensitive areas, or public/private property.



4.4 Surface Water Releases

If an IR occurs within streams and/or wetlands, drilling operations will cease until the HDD Drilling Supervisor, Dominion Energy Pipeline Inspector and Dominion Energy Environmental Lead have had an opportunity to examine the site and evaluate the threat to the waterbody. A turbidity curtain (Type 3 DOT or approved equivalent) will be installed per manufacturer instructions within the waterbody at the site of the inadvertent return location to confine suspended solids from the IR until an observable degree of settlement occurs. If necessary, the containment shall remain in place throughout HDD installation and until settlement renders turbidity inside the containment similar to the adjacent waters based on visual inspection, the threat to sensitive resources has passed, or the Dominion Energy Environmental Lead authorizes removal of the turbidity curtain. Removal of the diluted drilling fluids is not anticipated, unless dictated by unusual circumstances or directed by environmental agencies, and subject to Dominion Energy approval.

Drilling operations shall not cease during the pipe pullback process in the event of an inadvertent release due to significant risk of causing the pull to be stuck and unable to resume. In this case the turbidity curtain would be installed to confine suspended solids.

4.5 Wetland Releases

Upon confirmation of an IR in wetlands, HDD operations will cease. Containment and removal of drilling fluids released to wetlands shall be performed after consultation with the appropriate regulatory agencies. The HDD Contractor shall assist the on-site Dominion Energy Environmental Inspector with the following steps:

- Measure the area directly affected by the released drilling fluids. The area affected may be estimated from a distance, if access to the affected area for measurement would result in additional unacceptable negative impacts or is not otherwise feasible.
- The Dominion Energy Environmental Inspector or a qualified wetland biologist will characterize the type of impact caused by the released drilling fluids (e.g., temporary, vegetation only, permanent, change in surface hydrology). The Dominion Energy Environmental Inspector or Dominion Energy Environmental Lead will seek regulatory agency concurrence, if required.
- The HDD Contractor, Dominion Energy Pipeline Inspector, and the on-site Dominion Energy Environmental Inspector shall jointly estimate the additional area, if any, likely to be affected if the drilling were to proceed and the drilling fluids were not contained and removed.
- In consultation with the HDD Contractor, the on-site Dominion Energy Environmental Inspector will estimate and characterize the additional impacts to wetlands likely to occur as a result of accessing the affected area for containment and removal of the drilling fluids.
- The on-site Dominion Energy Environmental Inspector will estimate any reduction in impacts that might be achieved if the released fluids were removed.
- If it is determined that the released drilling fluid is to be contained and recovered, the HDD Drilling Supervisor, in consultation with the Dominion Energy Pipeline Inspector and Dominion Energy Environmental Inspector, shall direct the personnel or placement of equipment at the applicable points of fluids release and transfer the contained fluids to a hopper barge or tank for subsequent reuse or disposal.
- If the decision is made to forgo containment and proceed with the drill, the on-site Dominion Energy Environmental Inspector will continue to observe the location of the release. If impacts continue, the Dominion Energy Pipeline Inspector will periodically reevaluate the decision to continue until containment and removal are justified or the HDD is complete.



- Access to wetlands will be done in such a manner as to cause the least impacts to vegetation and surface hydrology, and only with prior agency approval. Because of site-specific variables such as distance from open water, surface hydrologic conditions, and vegetation cover, selection of the most appropriate access method will be made on a case-by-case basis, subject to approval by the Dominion Energy Pipeline Inspector and Dominion Energy Environmental Inspector. The least number of personnel and equipment necessary to accomplish the task safely in a timely manner shall be deployed.
- Following containment and removal, the HDD Contractor will continue to monitor the crossing location for additional releases as the drilling work progresses.
- Impacts to wetlands from inadvertent releases will be measured, assessed, and recorded by the Dominion Energy Environmental Inspector with assistance from the HDD Contractor, to support mitigation or restoration measures that may be necessary.
- Upon completion of the boring, the HDD Contractor will remove containment and recovery equipment, tools, supplies, materials, wastes, and debris from the wetlands.

5.0 Restoration and Post-Construction Monitoring

Impacted areas will be restored to pre-existing contours. Upland areas shall be restored through typical right-of-way practices of seeding and mulching as described in the reclamation plan for the project.

Restoration of wetlands may vary depending on the extent of disturbance to the upper soil layer and vegetation during the initial IR response.

In the event of a drilling fluid release in streams and/or wetlands, a site-specific, post-remediation protocol shall be prepared and submitted to the USACE and SCOCRM. Once approved, the plan implemented under the direction of Dominion Energy. This protocol will be based on the specific parameters of the release, including volume, location and extent. The goal of the plan will be to determine what adverse effects may have occurred in the impacted area of release. Efforts may include random sampling of each habitat and comparison of impacted habitats to non-impacted habitats. Pre-drilling data for this project will be used for comparative purposes.

At a minimum, an inspection of the entire drill path will occur within 48 hours of completion of drilling activities. A letter report will be prepared to summarize fluid deposits that are identified. If there is no drilling fluid release, post drilling monitoring will consist of an underwater investigation to be performed within 30 days after completion of drilling activities. Drilling fluid releases that persist beyond completion of drilling activities shall be removed within 30 days of completion of drilling, if requested by the Federal or State regulatory agencies having jurisdiction.

Appendices

Appendix I

IR Contingency Minimum Required Equipment List

- 4" – 6" Trash Pumps
- 40' Suction Hose
- 1500' Lay Flat Hose
- Straw Bales – Entry and exit side
- Silt Fence
- Sand Bags
- Plastic Sheeting
- Shovels, brooms, and appropriate hand tools
- Generator and Flood Lights for night work
- Frack Tanks (2) or mud pit large enough for excess mud
- Super Sacks (3) if needed to contain mud
- MSDS for the drilling mud and additives
- Long Reach Excavator for containment and cleanup of drilling mud

EXHIBIT C

Blue Ridge Environmental Defense League

www.BREDL.org PO Box 88 Glendale Springs, North Carolina 28629 BREDL@skybest.com (336) 982-2691

June 11, 2021

Jocelyn G. Boyd, Esquire
Chief Clerk & Administrator
Public Service Commission of South Carolina
101 Executive Center Drive, Suite 100
Columbia, South Carolina 29210
contact@psc.sc.gov

RE: Docket No. 2020-247-A
Public Service Commission Review of Regulations Chapter 103
Pursuant to S.C. Code Ann. Section 1-23-120(J)

Dear Administrator Boyd:

Pursuant to the “Notice and Request for Comments Regarding Proposed New Pipeline Regulation” filed April 23, 2021, in the above referenced docket, I submit these comments on behalf of the Blue Ridge Environmental Defense League and its members in South Carolina. These remarks will supplement my written comments of April 6 and oral comments of April 16, 2021.

General Comments

In a peer reviewed study published in May 2021 by NC State University, the authors released their nationwide investigation of natural gas gathering and transmission pipelines. It revealed a disturbing correlation between the level of pipeline development and negative social impacts.¹ The NCSU study considers racial composition, age distribution and socioeconomic factors in a “social vulnerability index” (SVI), a measure of a community’s ability to cope with pollution, accidents and other hazards.

SVI is widely accepted. The US Centers for Disease Control and Prevention uses SVI to determine a community’s resilience to respond to human and financial losses.

Social vulnerability refers to the potential negative effects on communities caused by external stresses on human health. Such stresses include natural or human-caused disasters, or disease outbreaks. Reducing social vulnerability can decrease both human suffering and economic loss.²

The study determined that SVI would be a reliable way to measure social impacts resulting from industrial projects such as pipelines.

¹ Ryan E. Emanuel, Martina Angela Caretta, Louie Rivers, Pavithra Vasudevan. “Natural Gas Gathering and Transmission Pipelines and Social Vulnerability in the United States” *GeoHealth*, 2021; DOI: 10.1029/2021GH000442

² CDC/ATSDR Social Vulnerability Index, <https://www.atsdr.cdc.gov/placeandhealth/svi/index.html>

Geospatial factors were compiled to correlate with the social vulnerability index. The study developed a pipeline density factor, based on US Dept of Energy data and measured in kilometers of pipeline per 100 square kilometers of land area.

The result of the study was that communities with the most vulnerable populations are those with the highest pipeline density. Pipeline density is significantly greater in communities with the highest social vulnerability. And the correlation indicates the greater the density, the greater the vulnerability. The study concludes:

The correlation between pipeline density and social vulnerability is a previously undocumented characteristic of the US natural gas gathering and transmission pipeline network. Relationships between [pipeline density] and SVI suggest that nationally, negative impacts associated with natural gas pipelines, including air and water pollution, public health and safety concerns, and other burdens, fall disproportionately on communities with already limited capacities to deal with challenges created by these impacts.

The study identifies 36 fatal accidents, 164 injuries and \$2.5 billion in costs (including property damage) from *natural gas gathering and transmission pipelines* during the 20-year period between 2001 and 2020. Gas gathering and transmission pipelines are considered “midstream infrastructure,” which does not include upstream infrastructure, such as hydraulic fracturing and directional drilling, and downstream infrastructure, such as refineries and end uses. Intrastate pipelines, such as the proposed Riverneck-Kingsburg project, are midstream infrastructure.

BREDL reviewed SVI data compiled by CDC for Florence County, SC which indicate that there already are moderate to high levels of social vulnerability in the census tracts in the Pamplico area of Florence County. An existing pipeline of 8-inch diameter traces the route of the 16-inch line proposed by Dominion Energy.

Census Tract ³	Social Vulnerability Index ⁴	Relative Level
16.02	0.7041	Moderate to High
17	0.7094	Moderate to High
18	0.8477	High
19	0.8194	High

SVI values range from 0.0000 (least vulnerable) to 1.0000 (most vulnerable).

The NCSU study posits that the demonstrated inequitable distribution of pipeline infrastructure may be an “emergent property of an inherently complex system of governance.” In other words, “overt discrimination and malicious intent are not prerequisites for discriminatory outcomes” (as posed by Dr. Robert Bullard and others). Nevertheless, the legacy of past practices and the prospect of current proposals may

³ US Census Data:

https://www2.census.gov/geo/maps/DC2020/PL20/st45_sc/censustract_maps/c45041_florence/DC20CT_C45041.pdf

⁴ SVI Interactive Map, <https://svi.cdc.gov/map.html>

already have caused disruption of the Pamplico community. The study recommends consideration of this environmental justice question:

Is it in the public interest to preserve or exacerbate existing patterns that disproportionately burden vulnerable populations with negative impacts from natural gas pipelines?

The Public Service Commission has a defined responsibility and authority, yet it is part of the complex system of governance which now faces an emergent problem. We hereby request that the Commission exercise its broad jurisdiction over matters pertaining to the investor owned electric and gas utility companies and take steps to protect the people faced with devastating disruption of their communities by climate-killing natural gas pipelines in Pamplico and elsewhere.

Specific Comments

I have attached to this letter the seven pages of residents, family members and landowners who signed their names to the petition stating: "Pamplico Stop the Pipeline." One hundred and eighteen people signed the petition.

Theresa Hyman also sent an email detailing her reasons for opposing the pipeline. She states:

Our early contact was regarding a Right of Way that they had acquired by way of an agreement from 1963 that gave them permission to implement some piping. This so called agreement gave them Lifetime rights to do just that even though Mrs Rosa Hyman had long ago passed away. We received a proposal and Affidavit for both parcels of land seeking permission as well to remain on the land forever. Moreover, they presented an so called agreement dated 1965 that included Mrs. Rosa Hyman and her children signatures even though they did not present a deed of joint tenancy to the Fleming Town property. This proposal included consideration of \$625.00 to remain on both parcels of land forever including the Davis Town property. Dominion Energy project was conveyed first as a Right Of Way then an Easement and now a Pipeline. We've been told it was for PUBLIC USE. Nevertheless, this use would not be beneficial to any of the land owners this pipeline would cross. This pipeline could sour the land as well as the drinking reservoirs of the communities that are present. While many use the Pee Dee river for fishing that too could diminish as a result of, a gas pipeline.

I conclude, that No pipeline crossing any parcels of land would benefit anyone in Davis Town or Fleming Town therefore, public use is not present in Dominion Energy pipeline project. By contemplating eminent domain which will devalue Properties this corporation has not made an offer that the 5th

Amendment and 14th Amendment stated as a right that should be adhered to should they go forth with this project.

Respectful, I am

Mrs Theresa Hyman

As you know, the Fifth and Fourteenth Amendments to the Constitution, cited here by Theresa Hyman, state in relevant part “nor shall private property be taken for public use, without just compensation” and “nor shall any State deprive any person of life, liberty, or property, without due process of law.” Our members are confronted with a proposed 14-mile natural gas pipeline in the Pamplico community of Florence County. The transition of the United States policy from energy independence to energy dominance as articulated in 2019 has erased any remaining pretense for eminent domain for energy projects.

In her petition to stop the pipeline currently circulating in Pamplico, Rev. Reatha L. Jefferson wrote: “They are using the terminology ‘eminent domain’ to secure the rights to invade your property, and say it is for the good of the community. This is not true; it is not for the good of the community.” She is correct.

Conclusion

The NCSU study determined that: “For the 2,261 US counties containing natural gas pipelines, we found a positive correlation between county-level pipeline density and an index of social vulnerability.” As the Commission considers the current regulations in its formal review under this docket, we ask that it implement changes to rebalance the system which no longer works for the good of the community. The experience of Rev. Jefferson was a bellwether; now 117 people have signed in support of her petition.

We call for an end to the Riverneck-Kingsburg pipeline based on its clearly disproportionate impacts on health and welfare. We call for adoption and timely implementation of the rules drafted by Southern Environmental Law Center: Subarticle 9, New Pipelines §103-495 Construction of Pipeline in An Area Where the Gas Utility Does not Currently Have a Pipeline. We call for a landowner bill of rights.

Respectfully submitted,



Louis A. Zeller, Executive Director
Blue Ridge Environmental Defense League

Attachment: Petition

Blue Ridge Environmental Defense League

www.BREDL.org PO Box 88 Glendale Springs, North Carolina 28629 BREDL@skybest.com (336) 982-2691

MAR 20 2021

To the Residents of Pauplico S.C.

As descendants of Slaves;
The the heirs of Mr. Andrew Hyman;
are calling upon all of you;
to stand with us to protect the
community we all love.

Some of you are descendants,
Some heirs of property, and
Some of you are property owners.
But all of us will be affected
by the proposal of the River
Neck to Kingsburg 16" Gas Main
Line.

you probably have received some
type of notification by now that
Dominion Energy is planning to
run pipelines to pump their
gas throughout our families
land. They are using the
terminology "Eminent Domain"
to secure the rights to invade
your property, and say it is
for the "good of the community"
this is not true, it is not
for the good of the community,
because most of you use
electricity for your appliances,
they will offer you money, (a few
hundred dollars to run these
pipelines throughout the community,

up and down your roads,
But what they won't tell you, is
how they will build access
roads, and tear up your
property while doing so. They
will also install pumping
stations, running for 7 days
a week and 24 hours a day.

Ask yourself:

- 1.) How safe are these Pipelines?
- 2.) What damage will be done to
my property
- 3.) How thick are the Pipelines
and will they hold up after
heavy traffic
- 4.) How will these Pipelines
affect my health and that
of my family?

Please Sign the petition to Stop
the Pipeline

Pamlico Stop the Pipeline Petition

1. Rev Reatha L. Nyman Jefferson (Andrew Nyman Family)
2. Willie Mae Rogers
3. Larry L. Jefferson I
4. Christopher E. Covington
5. Denise Rogers
6. Leon Rogers
7. Joan Davis
8. Andrea Mumford
9. Kenny Lee
10. Ella Couperd
11. Michelle Parker
12. Brianna Cain
13. Tony Davis
14. Lawrence Davis
15. Deborah Lee
16. Azalee Smith
17. Annie M. Johnson
18. Lillie M. Melvin
19. Marsha Smith
20. Wilbert Gudmae
21. Alisa Thompson
22. Gladys Johnson
23. James Brown
24. Monroe Dowdy
25. Jimmy Todd
26. Judy McDonald
27. Ben Delp
28. Patricia Todd
29. Glen Todd
30. Barbie Todd
31. Barry Todd
32. Kenneth Morrow

Pamplico Stop the Pipeline Petition

- 1 Robert Edwards
- 2 William Hope
- 3 ~~Delia~~
- 4 Nick Kachee
- 5 Cathi Kachee
- 6 Austin Davis
- 7 ~~Delia~~
- 8 ~~Wesley~~
- 9 Jonathon Faircliff
- 10 Jay Lee
- 11 Chond Hutt
- 12 Edwin Hamble
- 13 Eartha Ham
- 14 Harry Green
- 15 Mont Johnson
- 16 Sarah Green
- 17 John White
- 18 Edith Weauer
- 19 Alean Thomas
- 20 Genevieve Frazier
- 21 Ellen Hairey
- 22 Betty Fulton
- 23 Wayne Fyfe
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Pamphico Stop the Pipeline Petition

- 1 Shirley Wilson
- 2 Timothy M. [unclear]
- 3 [unclear]
- 4 [unclear]
- 5 Dorothy M Williams
- 6 [unclear]
- 7 [unclear]
- 8 [unclear]
- 9 [unclear]
- 10 [unclear]
- 11 [unclear]
- 12 Yolanda Johnson
- 13 [unclear]
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Pamplico Stop the Pipeline Petition

- 1 Tara S. Shuler
- 2 June Waters - Barnes
- 3
- 4 ~~John A. Shuler~~
- 5 ~~John A. Shuler~~
- 6 Megan Shuler
- 7 Rosamund White
- 8 Kathryn S. Shuler
- 9
- 10 John A. Shuler
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Pamplico Stop the Pipeline Petition

- 1 Elena Hyman
- 2 Megan Hyman
- 3 Ian Selbst permission
- 4 Rose McCree permission
- 5 Hanna Hyman
- 6 Mitchell Hyman permission
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Pamphico Stop the Pipeline
Petition

- 1 ~~Frank DePezote~~
- 2 Mary Huddells
- 3 Robert Kuhn
- 4 Laura Miles
- 5 Wendy Smith
- 6 ~~ADA Collins~~
- 7 ~~ADA Collins~~
- 8 Roger Judge
- 9 Betty J Judge
- 10 Katrina Woods
- 11 Roselyn Hoodrum
- 12 Gene Perkins
- 13 Frances Perkins
- 14 Marlene Moore
- 15 Eric Moore
- 17 Wendy Moore
- 18 Wendy Moore
- 19 D: Anne Pinkney
- 20 Roland Jenkney
- 21 Ryan Z. H. Washington
- 22 Jody A. Davis
- 23 John Shug
- 24 Mattie B
- 25 Linda B
- 26 Andrew Jacobsen
- 27 Bobby B
- 28 Anne B
- 29 Jennie B
- 30 Kevin B
- 31 Alora Quin
- 32 Sylvester Baus
- 33 Debra Davis

Carlene Simmons

1. [Faint handwritten name]

2. [Faint handwritten name]

3. [Faint handwritten name]

4. [Faint handwritten name]

5. [Faint handwritten name]

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ACCEPTED FOR PROCESSING - 2021 June 11 4:23 PM - SCPSC - 2020-247-A - Page 13 of 13